
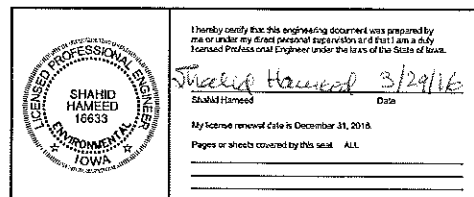


# IOWA DEPARTMENT OF NATURAL RESOURCES

## CONSTRUCTION DOCUMENTS FOR WATER TREATMENT SYSTEM REPLACEMENT LEWIS AND CLARK STATE PARK

### MONONA COUNTY, IOWA

**PROJECT #13-01-67-02**

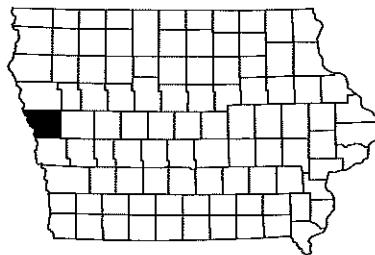

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B.07	WELL CAPPING DETAILS
C.01	ESTIMATE OF QUANTITIES
D.01	WATER TREATMENT BUILDING
D.02	WATER TREATMENT BUILDING
D.03	SITE PLAN

CONSULTANT:

**IOWA DEPARTMENT OF  
NATURAL RESOURCES**  
ENGINEERING SERVICES - WALLACE BUILDING  
502 E. 9TH ST., DES MOINES, IA 50319-0034



COVER SHEET

ACCESS ROAD CONSTRUCTION FOR:  
**LEWIS & CLARK STATE PARK**

FREMONT COUNTY, IA

DIRECTORY			
PROJECT MANAGER		CONSTRUCTION INSPECTOR	
COMPANY	IOWA DEPARTMENT OF NATURAL RESOURCES	COMPANY	IOWA DEPARTMENT OF NATURAL RESOURCES
ADDRESS	502 EAST 9TH STREET	ADDRESS	613 APOLLO RD
CITY,STATE,ZIP	DES MOINES, IA 50319	CITY,STATE,ZIP	HINTON, IA 51024-8827
CONTACT	MIKE HAMEED	CONTACT	JEFF FELTS
TELEPHONE	515-725-8467	TELEPHONE	515-250-3712
FAX		FAX	
EMAIL	Mike.Hameed@dnr.iowa.gov	EMAIL	Jeff.Felts@dnr.iowa.gov

**PROJECT DESCRIPTION**

THIS PROJECT CONSISTS OF DRILLING A NEW WELL, NEW WATER TREATMENT BUILDING WITH IRON REMOVAL, SOFTENING AND CHLORINE INJECTION SYSTEM AND DEMOLISHING OF THE OLD TREATMENT BUILDING & TANK AND OTHER INCIDENTAL WORK AS REQUIRED BY D.N.R CONSTRUCTION INSPECTOR AT LEWIS AND CLARK STATE PARK, MONONA COUNTY, IOWA.

**AUTHORIZATION TO BID**

AUTHORIZATION - PARKS | WILDLIFE | FISHERIES | LAW ENFORCEMENT | FORESTRY


*Shahd Hameed* 3/29/16

**ENGINEERING BUREAU CHIEF** DATE


NO.	BY	REVISION

DRWN BY:	PROJECT NUMBER:
MI	13-01-67-02
CHK'D BY:	DATE:
	JAN/2016
SHEET No.	<b>A.01</b>

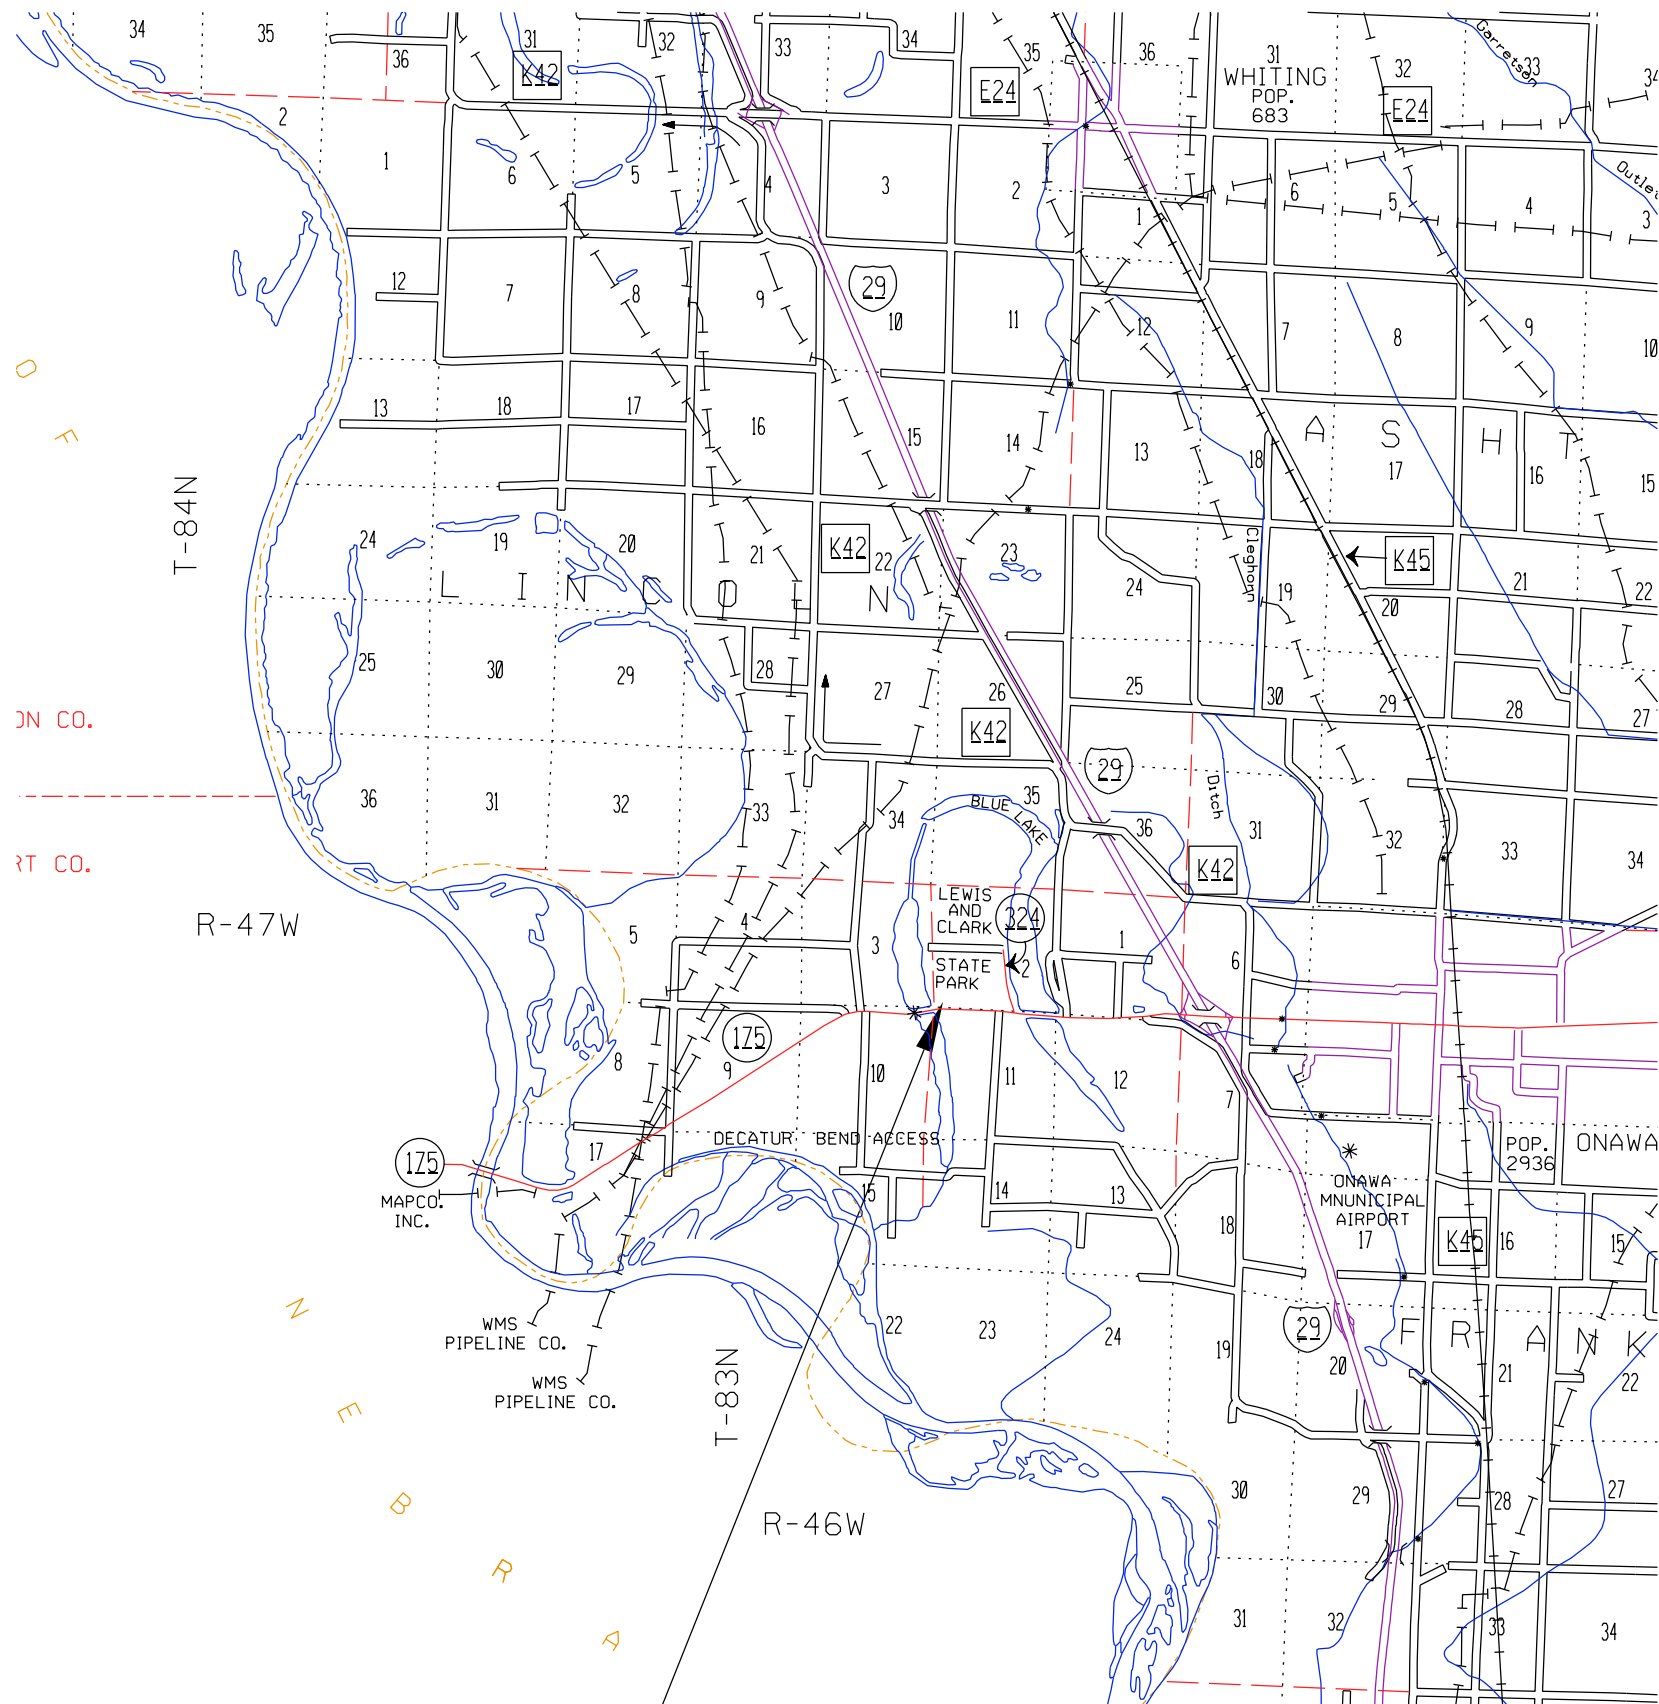


**PROJECT LOCATION**

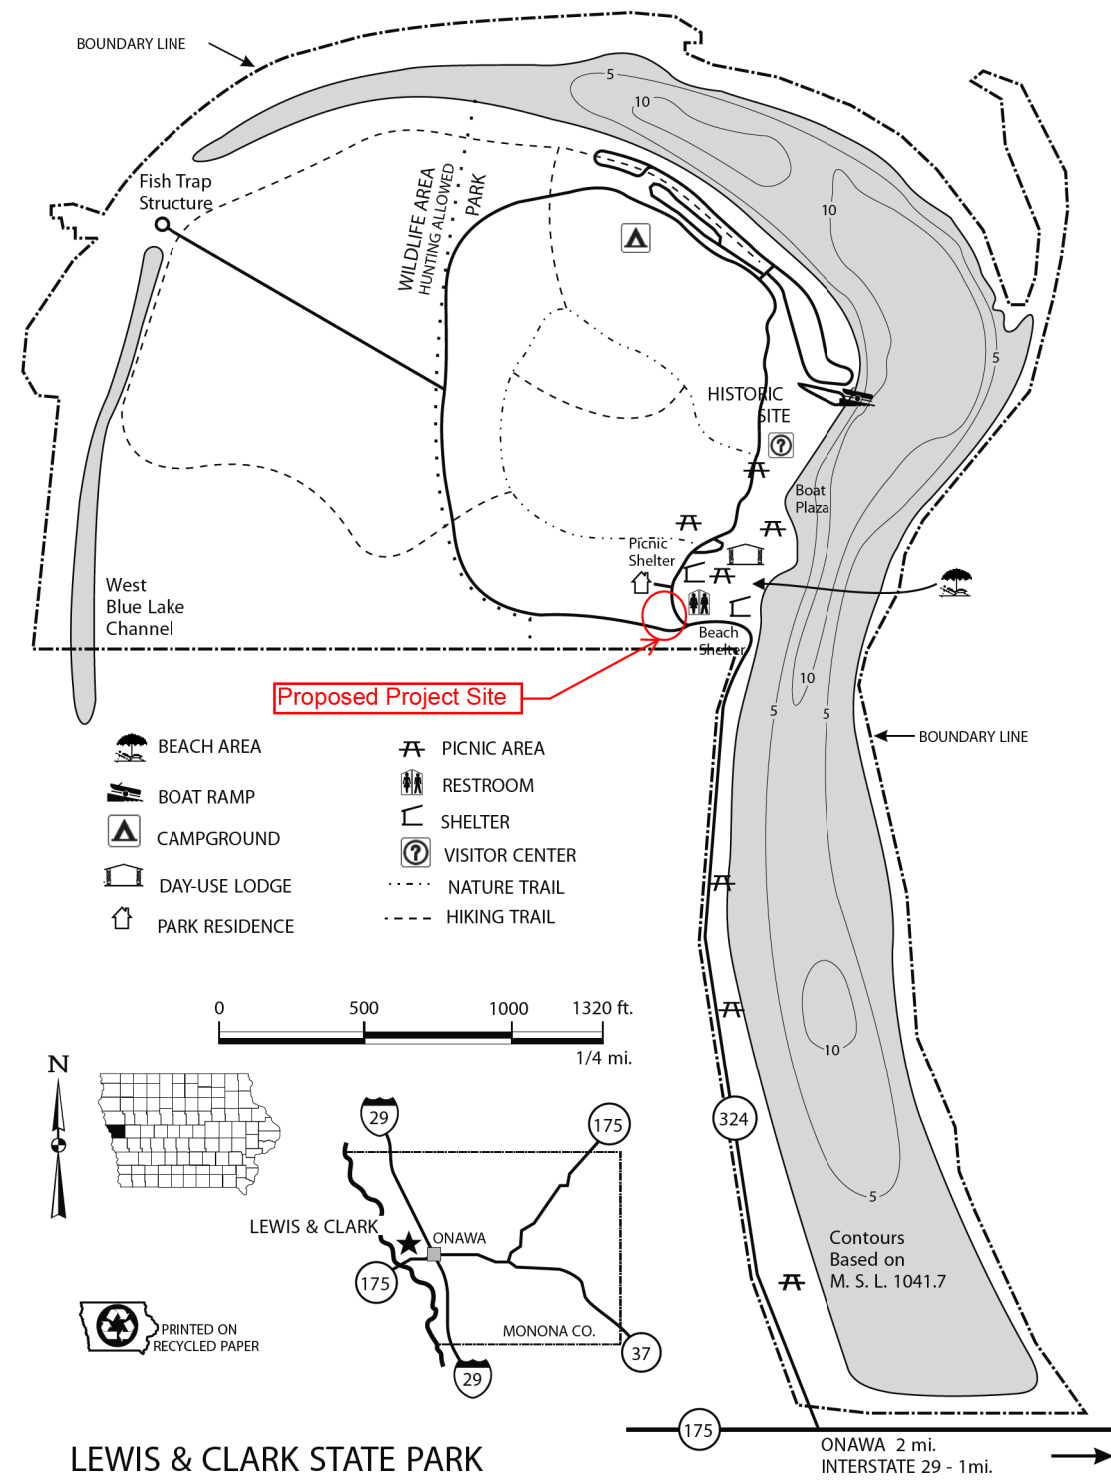

**LEWIS & CLARK STATE PARK**

CONSULTANT:

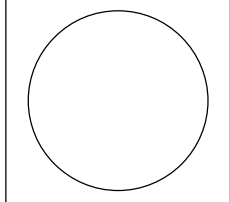

**IOWA DEPARTMENT OF NATURAL RESOURCES**  
 ENGINEERING SERVICES - WALLACE BUILDING  
 502 E. 9TH ST., DES MOINES, IA 50319-0034




**PROJECT LOCATION**  
 ACCESS ROAD CONSTRUCTION FOR:  
**LEWIS & CLARK STATE PARK**  
 FREMONT COUNTY, IA

NO.	BY DATE	REVISION


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 MH 13-01-67-02  
 CHK'D BY: DATE:  
 JAN/2016

SHEET No: **A.02**

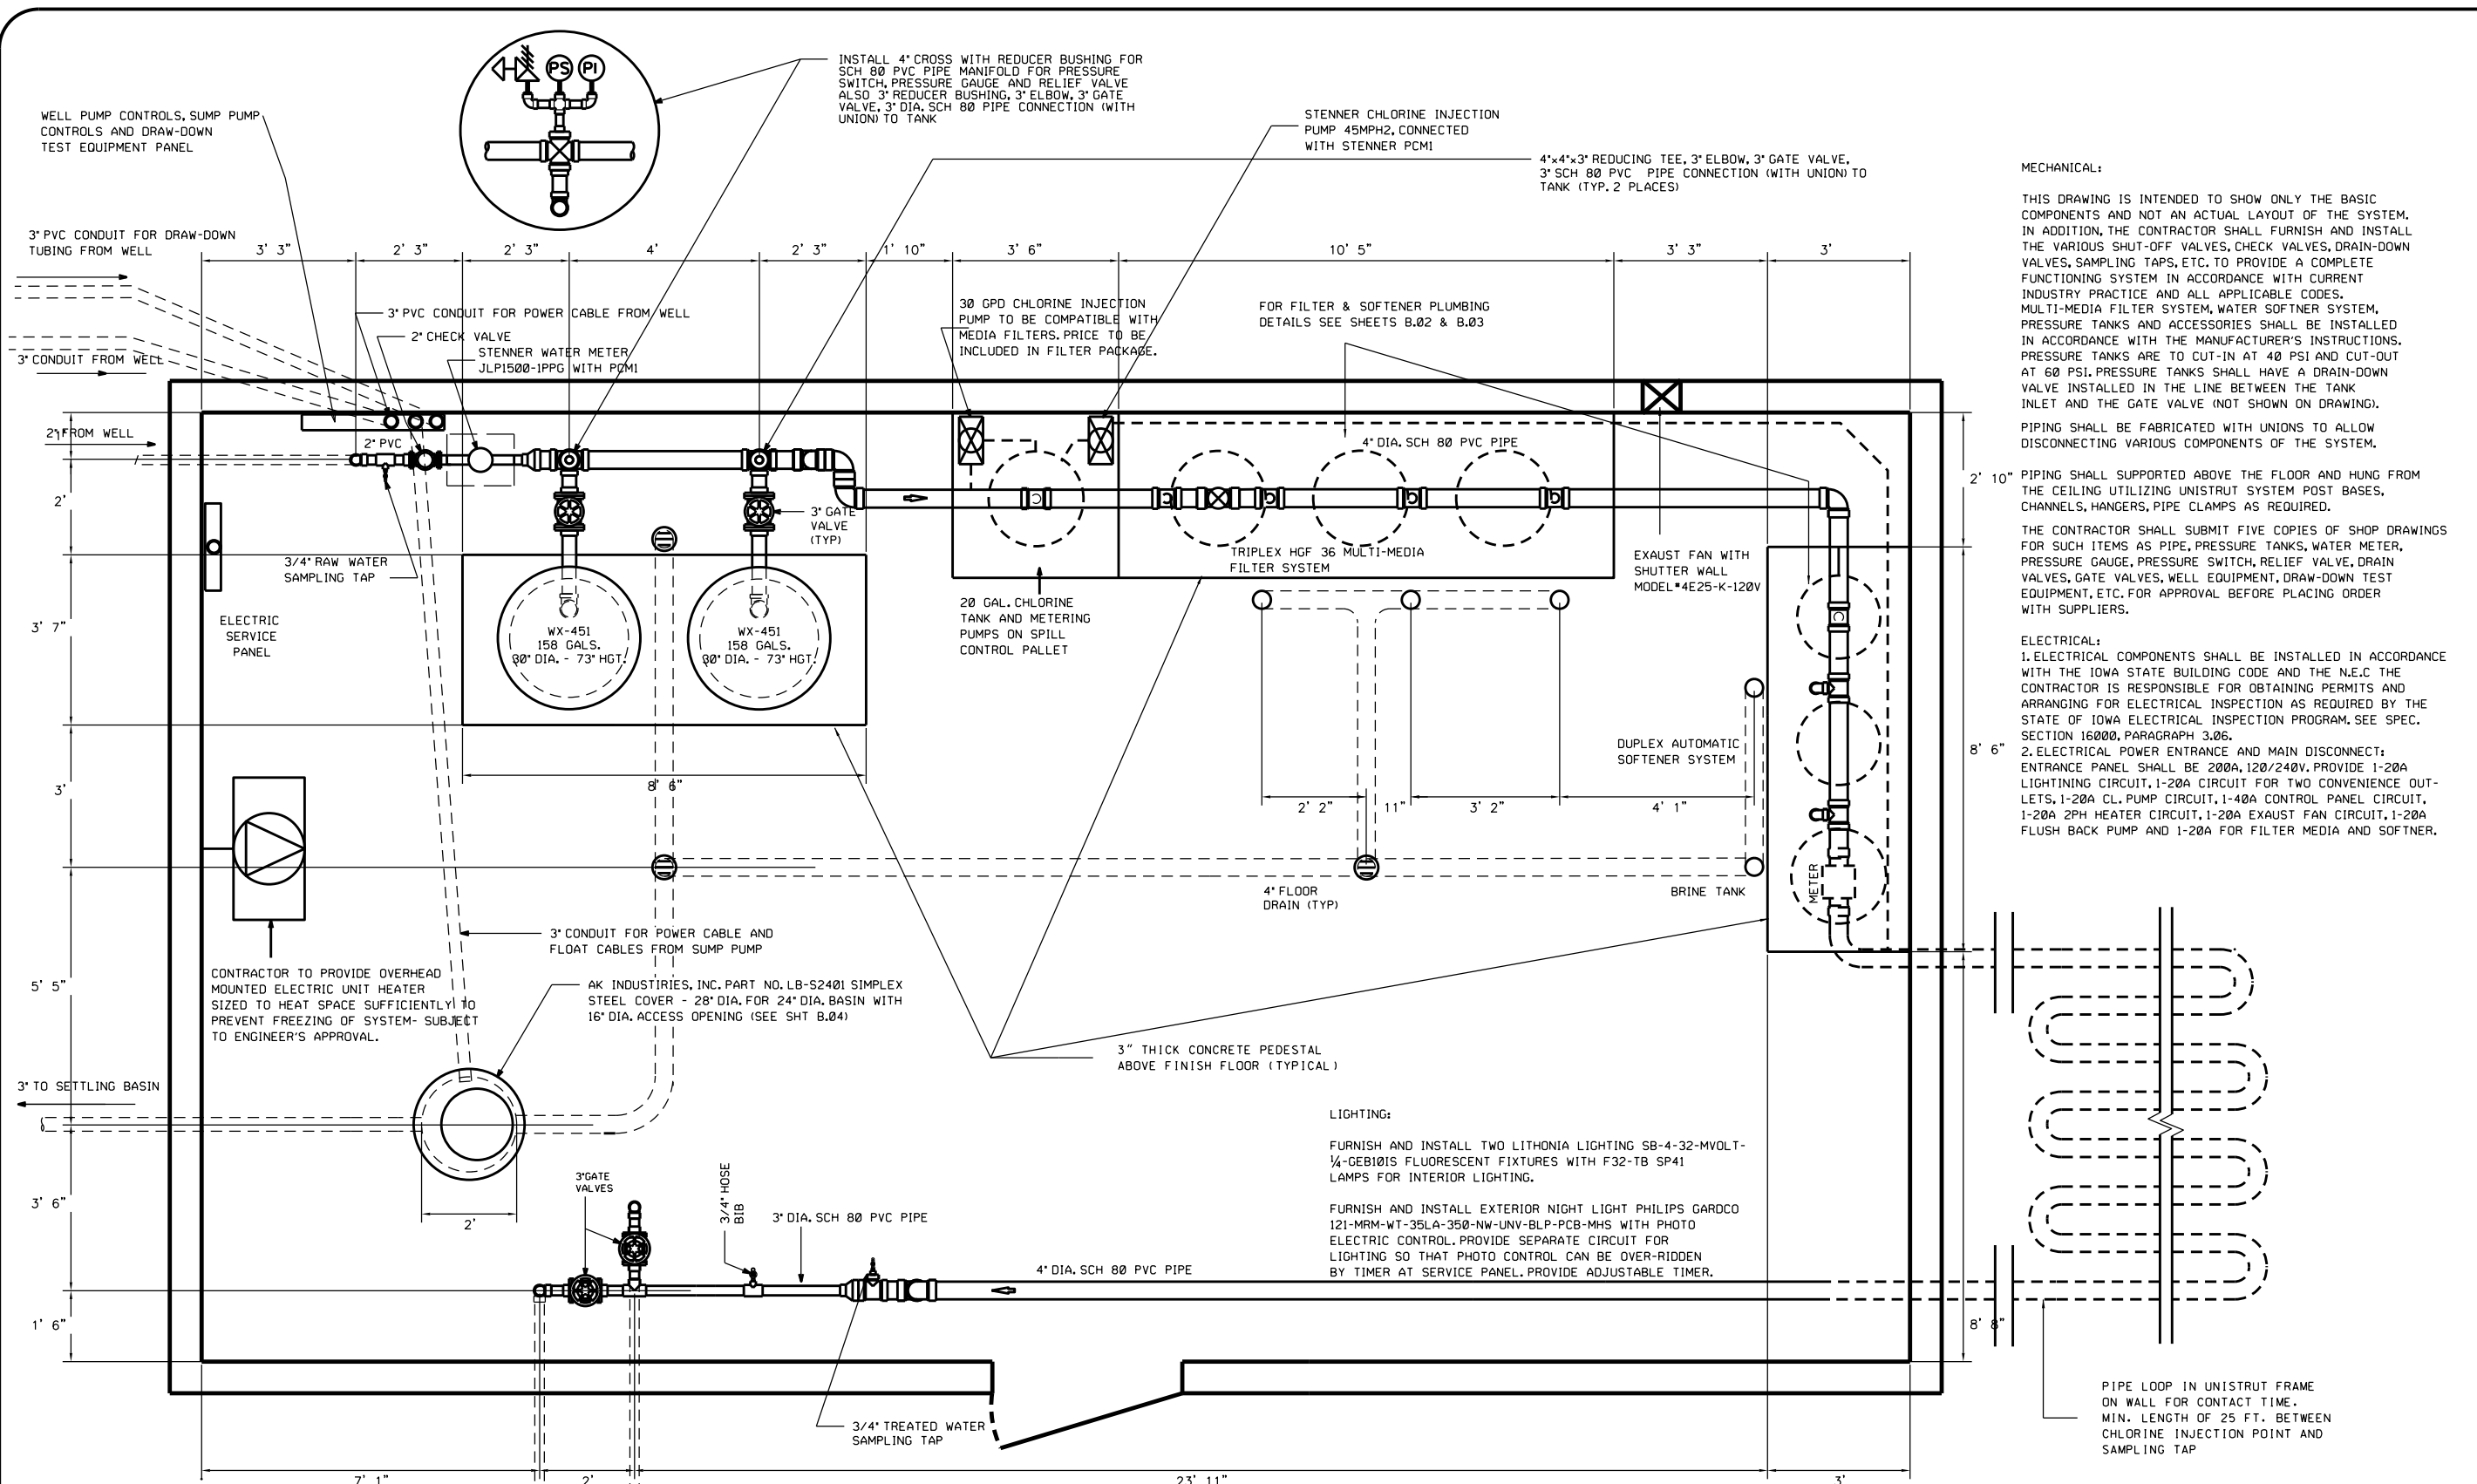

**PLAN**

CONSULTANT:

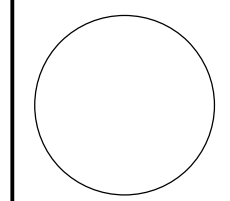

**IOWA DEPARTMENT OF NATURAL RESOURCES**  
 ENGINEERING SERVICES - WALLACE BUILDING  
 502 E. 9TH ST., DES MOINES, IA 50319-0034




**MECHANICAL LAYOUT**  
 WATER TREATMENT SYSTEM REPLACEMENT  
**LEWIS & CLARK STATE PARK**  
 MONONA COUNTY, IOWA



NO.	BY	REVISION

DRAWN BY:	PROJECT NUMBER:
MH	13-01-67-02
CHK'D BY:	DATE:
	7/9/2015

SHEET No: **B.01**

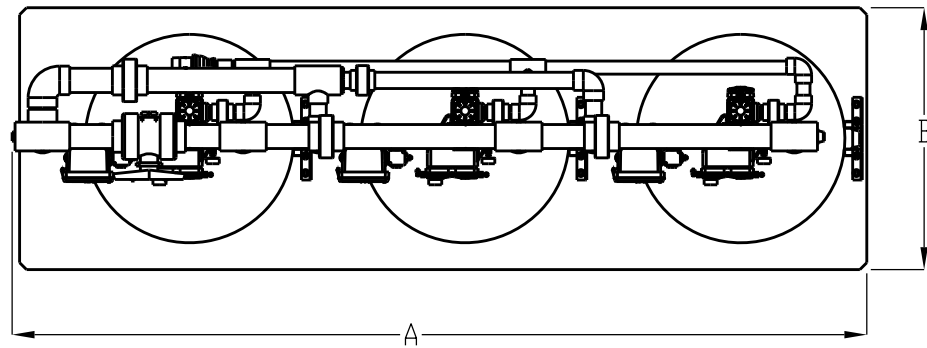

VALVE HANDLE  
IN CLOSED POSITION

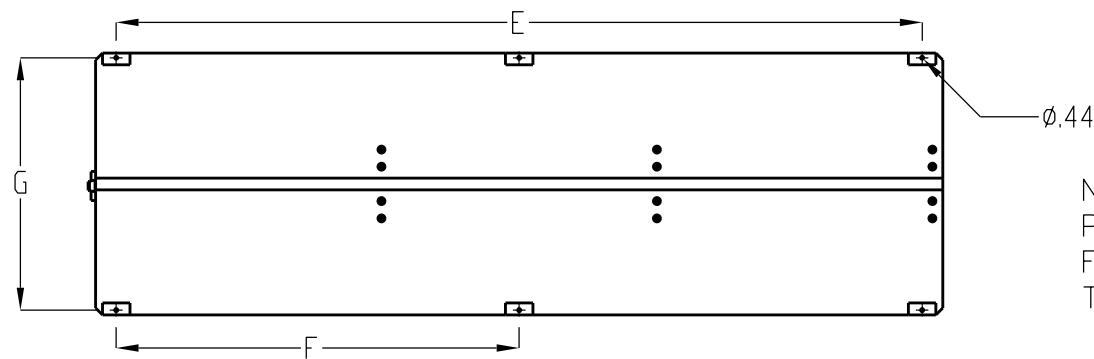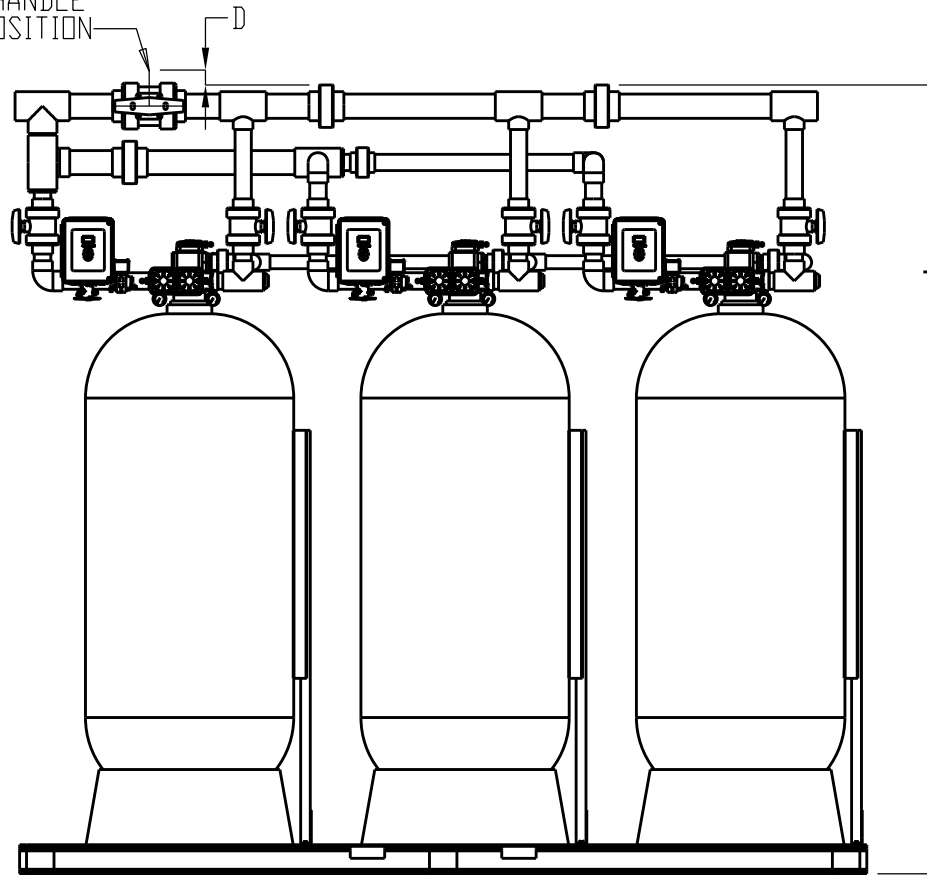

P/N	Model	System Length A	System Width B	System Height C	Valve Handle D	Inlet	Outlet	Skid Floor Mounting Hole E	Skid Floor Mounting Hole F	Skid Floor Mounting Hole G
01026623	HDF-20-T,Duplex,Prl,Galv,Skid	82.0	38.0	97.5	4.5	2" NPT	2" NPT	50.00		24.63
01026624	HDF-24-T,Duplex,Prl,Galv,Skid	82.0	38.0	104.5	4.5	2" NPT	2" NPT	50.00		24.63
01026625	HDF-30-T,Duplex,Prl,Galv,Skid	83.5	38.0	109.0	4.5	2" NPT	2" NPT	76.00		36.63
01026626	HDF-36-T,Duplex,Prl,Galv,Skid	86.5	38.0	111.5	4.5	2" NPT	2" NPT	76.00		36.63
01026627	HDF-20-T,Duplex,Prl,PVC,Skid	82.0	38.0	101.5	0.5	2" Soc	2" Soc	50.00		24.63
01026628	HDF-24-T,Duplex,Prl,PVC,Skid	82.0	38.0	108.5	0.5	2" Soc	2" Soc	50.00		24.63
01026629	HDF-30-T,Duplex,Prl,PVC,Skid	84.0	38.0	113.5	0.5	2" Soc	2" Soc	76.00		36.63
01026630	HDF-36-T,Duplex,Prl,PVC,Skid	87.0	38.0	115.5	0.5	2" Soc	2" Soc	76.00		36.63
01026631	HDF-20-T,Triplex,Prl,Galv,Skid	123.0	38.0	97.5	4.5	2" NPT	2" NPT	78.00	39.00	24.63
01026632	HDF-24-T,Triplex,Prl,Galv,Skid	123.0	38.0	104.5	4.5	2" NPT	2" NPT	78.00	39.00	24.63
01026633	HDF-30-T,Triplex,Prl,Galv,Skid	123.5	38.0	109.0	4.5	2" NPT	2" NPT	117.00	58.50	36.63
01026634	HDF-36-T,Triplex,Prl,Galv,Skid	126.5	38.0	111.5	4.5	2" NPT	2" NPT	117.00	58.50	36.63
01026635	HDF-20-T,Triplex,Prl,PVC,Skid	123.0	38.0	101.5	0.5	2" Soc	2" Soc	78.00	39.00	24.63
01026636	HDF-24-T,Triplex,Prl,PVC,Skid	123.0	38.0	108.5	0.5	2" Soc	2" Soc	78.00	39.00	24.63
01026637	HDF-30-T,Triplex,Prl,PVC,Skid	124.0	38.0	113.5	0.5	2" Soc	2" Soc	117.00	58.50	36.63
01026638	HDF-36-T,Triplex,Prl,PVC,Skid	127.0	38.0	115.5	0.5	2" Soc	2" Soc	117.00	58.50	36.63
01026639	HRF-20-T,Duplex,Prl,Galv,Skid	82.0	38.0	97.5	4.5	2" NPT	2" NPT	50.00		24.63
01026640	HRF-24-T,Duplex,Prl,Galv,Skid	82.0	38.0	104.5	4.5	2" NPT	2" NPT	50.00		24.63
01026641	HRF-30-T,Duplex,Prl,Galv,Skid	83.5	38.0	109.0	4.5	2" NPT	2" NPT	76.00		36.63
01026642	HRF-36-T,Duplex,Prl,Galv,Skid	86.5	38.0	111.5	4.5	2" NPT	2" NPT	76.00		36.63
01026643	HRF-20-T,Duplex,Prl,PVC,Skid	82.0	38.0	101.5	0.5	2" Soc	2" Soc	50.00		24.63
01026644	HRF-24-T,Duplex,Prl,PVC,Skid	82.0	38.0	108.5	0.5	2" Soc	2" Soc	50.00		24.63
01026645	HRF-30-T,Duplex,Prl,PVC,Skid	84.0	38.0	113.5	0.5	2" Soc	2" Soc	76.00		36.63
01026646	HRF-36-T,Duplex,Prl,PVC,Skid	87.0	38.0	115.5	0.5	2" Soc	2" Soc	76.00		36.63
01026647	HRF-20-T,Triplex,Prl,Galv,Skid	123.0	38.0	97.5	4.5	2" NPT	2" NPT	78.00	39.00	24.63
01026648	HRF-24-T,Triplex,Prl,Galv,Skid	123.0	38.0	104.5	4.5	2" NPT	2" NPT	78.00	39.00	24.63
01026649	HRF-30-T,Triplex,Prl,Galv,Skid	123.5	38.0	109.0	4.5	2" NPT	2" NPT	117.00	58.50	36.63
01026650	HRF-36-T,Triplex,Prl,Galv,Skid	126.5	38.0	111.5	4.5	2" NPT	2" NPT	117.00	58.50	36.63
01026651	HRF-20-T,Triplex,Prl,PVC,Skid	123.0	38.0	101.5	0.5	2" Soc	2" Soc	78.00	39.00	24.63
01026652	HRF-24-T,Triplex,Prl,PVC,Skid	123.0	38.0	108.5	0.5	2" Soc	2" Soc	78.00	39.00	24.63
01026653	HRF-30-T,Triplex,Prl,PVC,Skid	124.0	38.0	113.5	0.5	2" Soc	2" Soc	117.00	58.50	36.63
01026654	HRF-36-T,Triplex,Prl,PVC,Skid	127.0	38.0	115.5	0.5	2" Soc	2" Soc	117.00	58.50	36.63


NOTE: USE THIS DRAWING FOR PLUMBING DETAILS ONLY. ACTUAL FILTER MODEL USED IS HGF-36 TRIPLEX CULLSORB FILTERS.

REVISION	DESCRIPTION	DCO#	BY	DATE
	Release Data Sheets	013937	MKM	08-15-13

<b>Culligan</b> www.Culligan.com		The 3-D file for this item is the controlling document, from which all component and feature dimensions should be referenced and held, excluding threads. The intent of this drawing is to identify critical dimensions and tolerances for inspection.	
All information contained on this document is the property of, and proprietary to Culligan International. The design concepts and information contained herein are submitted in confidence, and may not be disclosed, reproduced, loaned, or used in any other manner without the expressed, written consent of Culligan International.			
MATERIAL	SIZE B	DRAWN BY MKM	TOLERANCES, UNLESS OTHERWISE SPECIFIED
	SCALE 1:25	APPROVED BY MKM	LAST DIGIT TOLERANCE
SHEET 1 of 1	APPROVED DATE 08-15-13		(inches) (millimeters)
			0. ± 0.030 ± 0.76
			0.0 ± 0.015 ± 0.38
			0.00 ± 0.010 ± 0.25
			0.000 ± 0.005 ± 0.13
			ANGULAR ± 0.5° ± 0.5°
PART DESCRIPTION	PART NUMBER	REV	
HF42 Systems Skid Mounted	DRW-1045	A	

CONSULTANT:

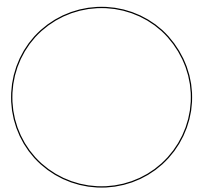

IOWA DEPARTMENT OF  
NATURAL RESOURCES

ENGINEERING SERVICES - WALLACE BUILDING  
502 E. 9TH ST., DES MOINES, IA 50319-0034



MULTI-MEDIA FILTER SYSTEM

WATER TREATMENT SYSTEM REPLACEMENT  
LEWIS & CLARK STATE PARK

MONONA COUNTY, IOWA

NO. BY DATE REVISION

DRAWN BY: PROJECT NUMBER:

MH: 13-01-67-02

CHK'D BY: DATE:

7/9/2015




SHEET No:

B.02

NOTES:

- (1) ITEMS SHOWN IN BROKEN LINES TO BE FURNISHED BY THE CONTRACTOR.
- (2) ALL DIMENSIONS ARE ± 1 INCH (25mm) AND SUBJECT TO CHANGE WITHOUT NOTICE.
- (3) UNIONS SHOULD BE LOCATED ON INLET AND OUTLET CONNECTIONS OF CONTROL VALVE TO FACILITATE SERVICING.
- (4) THE USE OF DISSIMILAR METALS IN A PIPING SYSTEM IS NOT RECOMMENDED. WHERE DISSIMILAR METALS MUST BE CONNECTED IN A WATER SYSTEM, THE USE OF NONCONDUCTIVE (DIELECTRIC) FITTINGS MAY REDUCE GALVANIC CORROSION.
- (5) AN ELECTRICAL OUTLET SHOULD BE PROVIDED WITHIN FIVE FEET OF THE EQUIPMENT LOCATION.
- (6) ALLOW A MINIMUM OF 24 INCHES ABOVE SOFTENER FOR FILLING.
- (7) TO PERMIT THE OBSERVATION OF THE DRAIN FLOW DO NOT MAKE A DIRECT CONNECTION TO THE DRAIN. PROVIDE AN AIR GAP OF AT LEAST FOUR TIMES THE DIAMETER OF THE DRAIN PIPE OR CONFORM TO LOCAL SANITATION CODES.
- (8) WHEN USING A WATER METER, THERE MUST BE A MINIMUM AMOUNT OF STRAIGHT PIPE BEFORE AND AFTER THE SENSOR. REFER TO THE INSTALLATION INSTRUCTIONS FOR DETAILS.
- (9) SYSTEM USES FRP TANKS WHICH MUST NOT BE SUBJECTED TO VACUUM. INSTALL SIPHON BREAK ON DRAIN LINE. INSTALL VACUUM BREAKER ON INLET PIPING IF THE SERVICE LINE IS SUBJECT TO A VACUUM.
- (10) FOR MAXIMUM PROTECTION OF THE CONTROLLER, IT IS RECOMMENDED THAT A DEDICATED 120 VOLT CIRCUIT IS PROVIDED.
- (11) BRINE TANK DIMENSIONS SHOWN ARE FOR THE BRINE TANK MOST COMMONLY SELECTED FOR USE WITH THIS SIZE SYSTEM.

MODEL	DIMENSIONS (INCHES)									UNIT DATA PER TANK								
	WIDTH A	HEIGHT B(6)	DEPTH C	TANK DIA. D	TANK HEIGHT E	INLET/OUTLET PIPE SIZES F	DRAIN SIZE G	FLOOR TO INLET H	BRINE TANK DIA. L(11)	BRINE TANK HEIGHT M(11)	MAX. CAPACITY KGR @ SALT DOSAGE	RESIN VOLUME ft <sup>3</sup>	CONTINUOUS FLOW gpm @ 15 psi drop	PEAK FLOW gpm @ 25 psi drop	DRAIN FLOW gpm	MIN. DRAIN PIPE SIZE IN.	DUPLEX OPER. WT. lbs.	DUPLEX SHIP. WT. lbs.
HCE-120-2	72	78	20	16	65.2	2.0	1.0	67.4	24	50	120 @ 60	4	45	60	8	1.0	2210	880
HCE-150-2	76	79	21	18	66.3	2.0	1.0	68.5	24	50	150 @ 75	5	60	78	8	1.0	2600	1060
HCE-210-2	82	80	22.5	21	67.1	2.0	1.0	69.3	24	50	210 @ 105	7	58	76	8	1.0	2950	1310
HCE-300-2	94	87	27	24	74.7	2.0	1.0	76.9	30	50	300 @ 150	10	65	85	15	1.25	4080	1800
HCE-450-2	106	92	30	30	78.9	2.0	1.0	81.1	30	50	450 @ 225	15	75	100	25	1.5	5590	2770

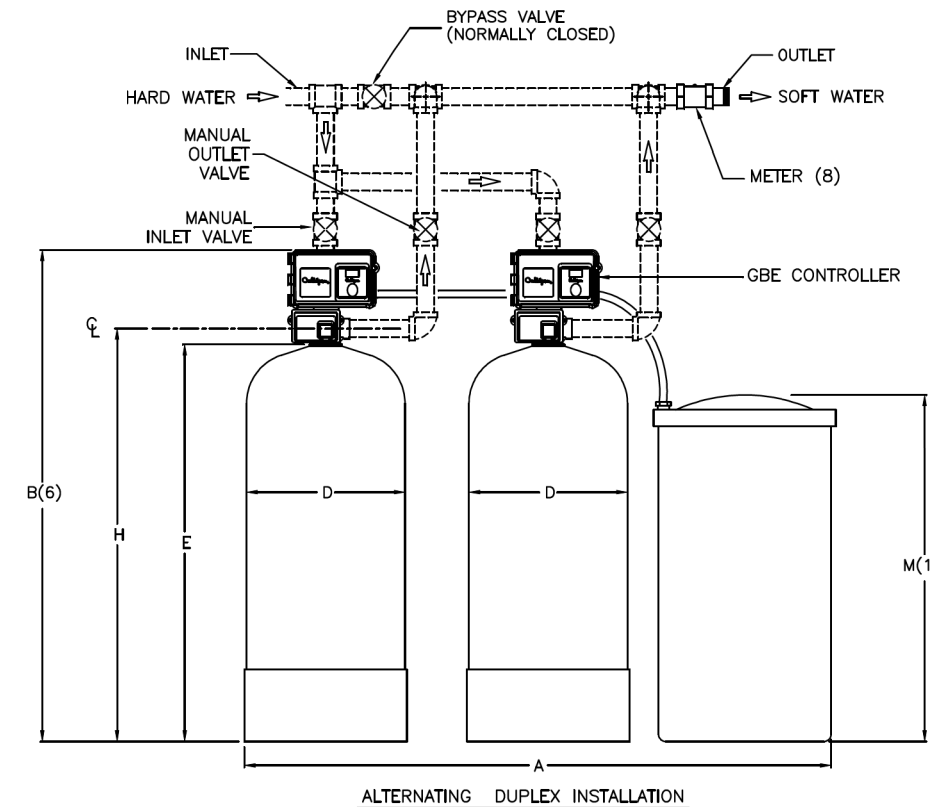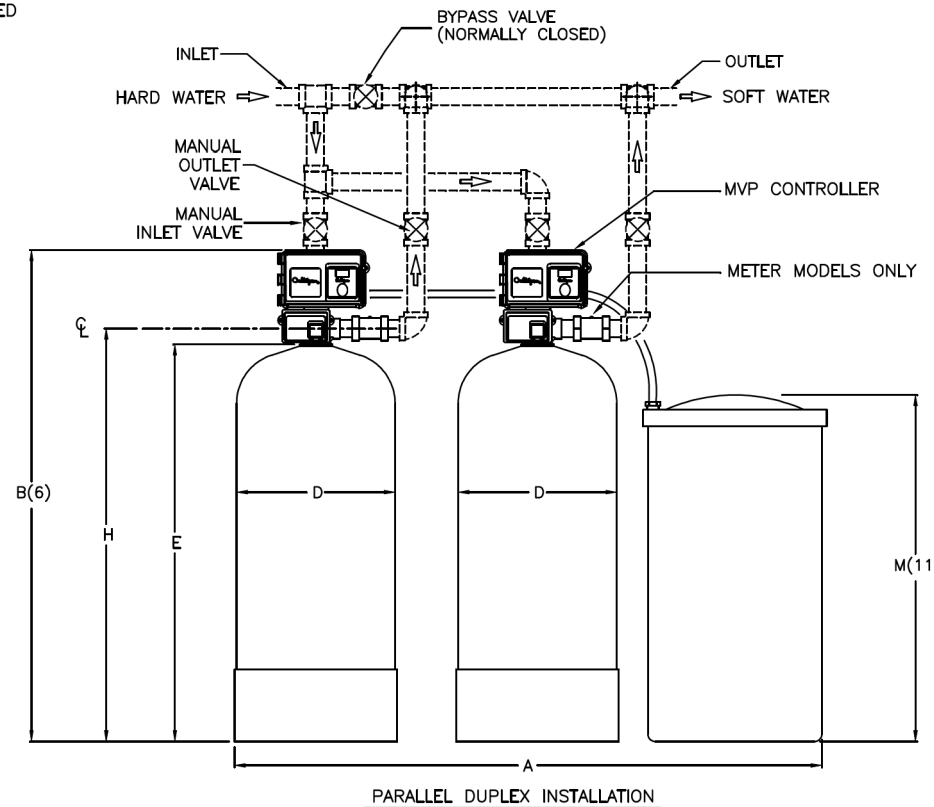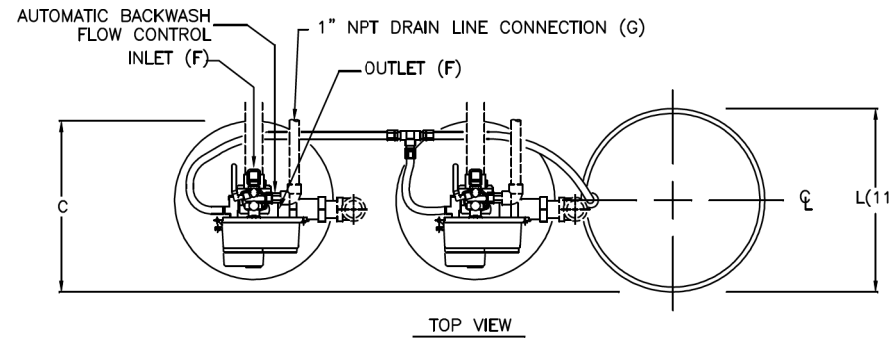


# Hi-Flo 3e

CAD File: Hi-Flo 3e Softener Duplex 2in.dwg

DO NOT SCALE DRAWING TOLERANCES: ±1/8" UNLESS OTHERWISE NOTED					<p><b>ENGINEERED SYSTEMS</b> ROSEMONT, ILLINOIS</p> <p>PRINT AND BILL OF MATERIAL ARE NOT TO BE USED WITHOUT THE WRITTEN CONSENT OF CULLIGAN INTERNATIONAL CO.</p>	NAME: HI-FLO® 3e AUTOMATIC SOFTENER DUPLEX TECHNICAL DATA SHEET		
Let.	Change	By	App	Date		DETAILED BY: KMR 5/03/05	APP. BY: KSR 01/19/10	SHEET 1 OF 1
						REF. NO.	PART NO. S3e_2_MVP	

CONSULTANT:

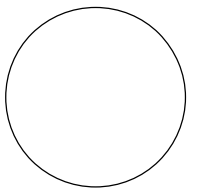

**IOWA DEPARTMENT OF NATURAL RESOURCES**

ENGINEERING SERVICES - WALLACE BUILDING  
502 E. 9TH ST., DES MOINES, IA 50319-0034



WATER SOFTENER LAYOUT

WATER TREATMENT SYSTEM REPLACEMENT  
**LEWIS & CLARK STATE PARK**

MONONA COUNTY, IOWA

NO. BY REVISION


DRAWN BY: PROJECT NUMBER:


MH 13-01-67-02

CHK'D BY: DATE:

7/9/2015

SHEET No:

**B03**

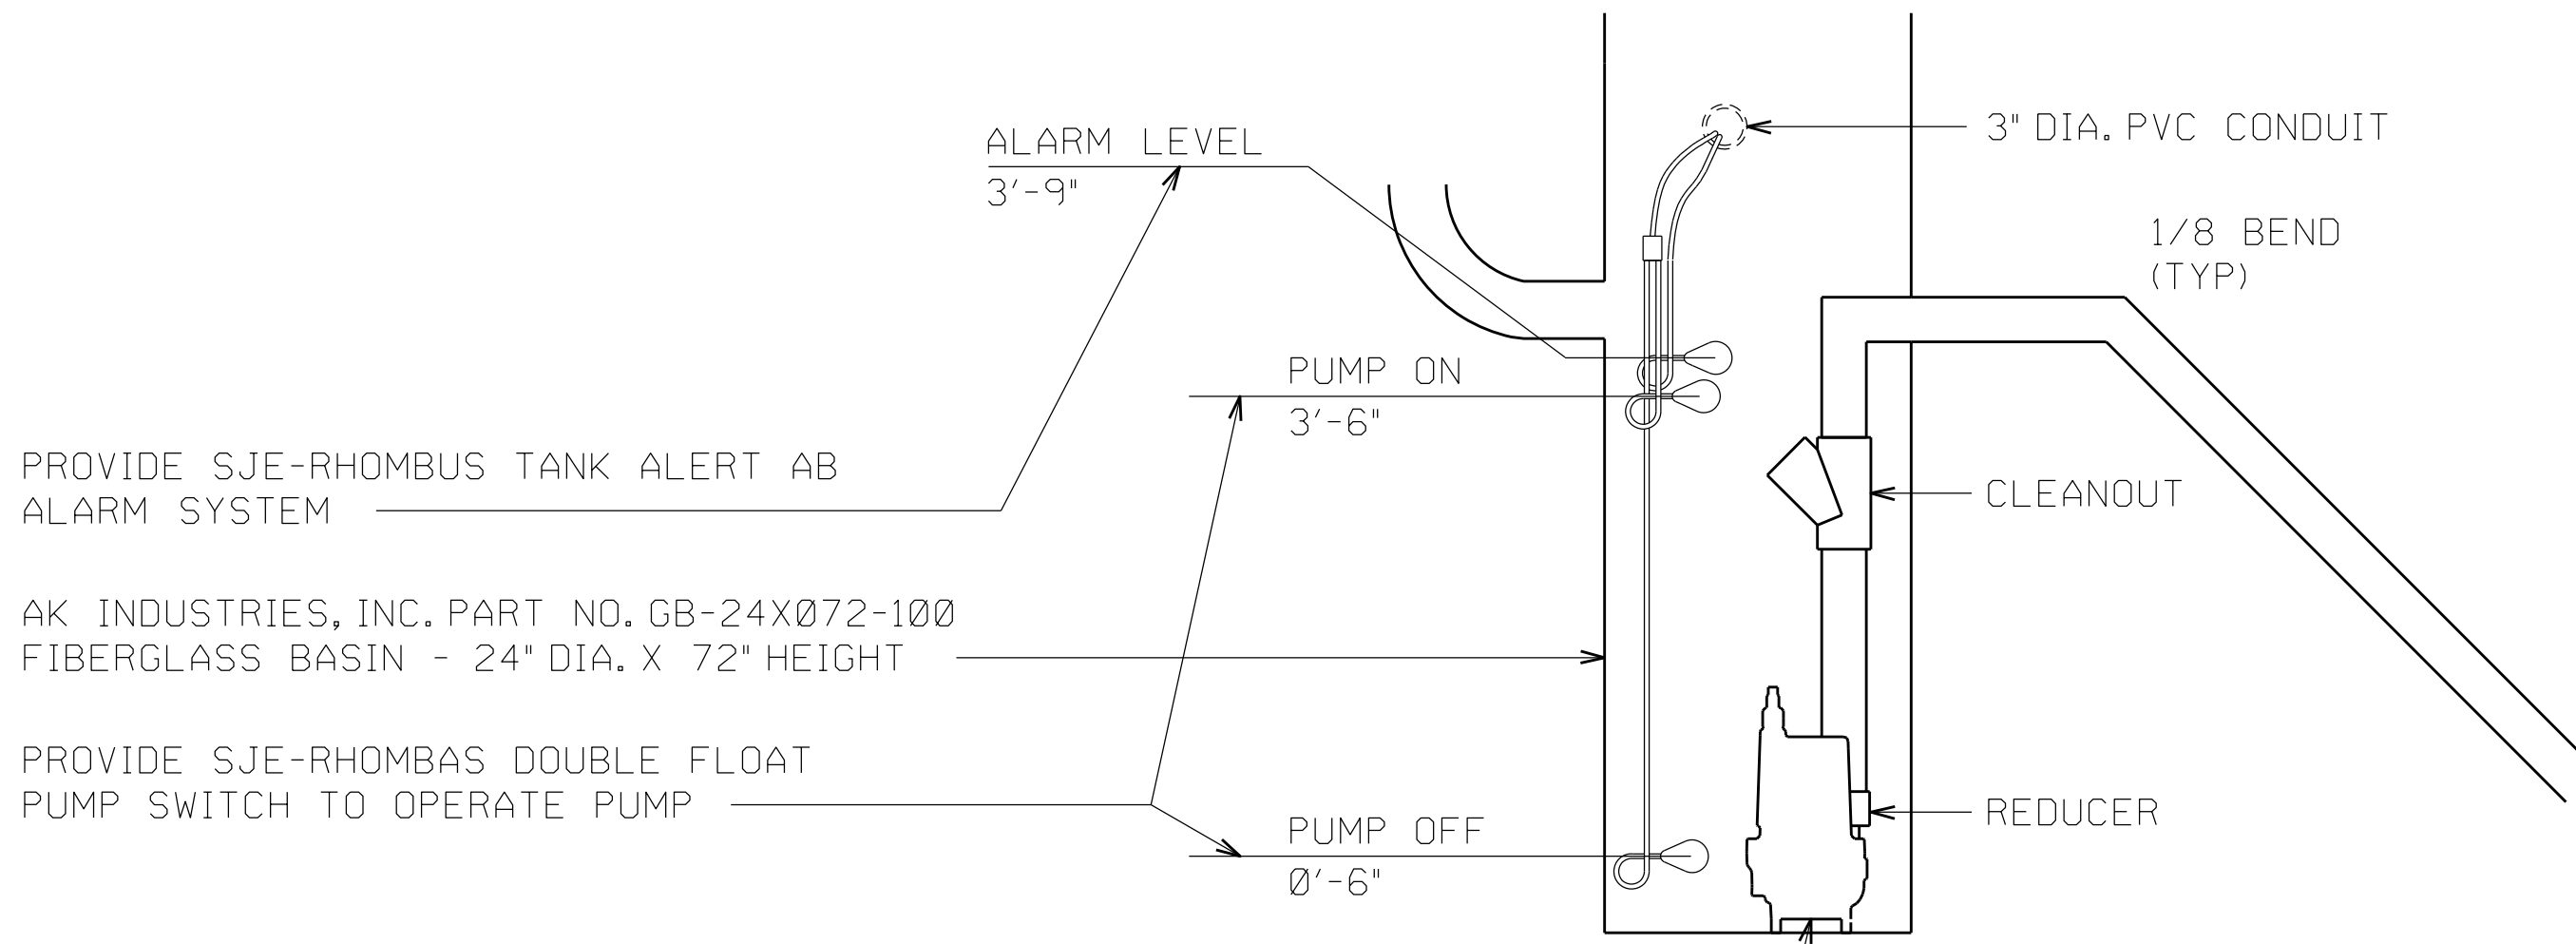

PROVIDE SJE-RHOMBUS TANK ALERT AB ALARM SYSTEM


AK INDUSTRIES, INC. PART NO. GB-24XØ72-1ØØ FIBERGLASS BASIN - 24" DIA. X 72" HEIGHT

PROVIDE SJE-RHOMBAS DOUBLE FLOAT PUMP SWITCH TO OPERATE PUMP

NOTE:  
ALL EQUIPMENT SHOWN CAN BE AS SPECIFIED OR APPROVED EQUAL

HYDROMATIC SKV4Ø EJECTOR PUMP  
4/10 HP, 175Ø RPM, 24Ø V, 1 PH, 2" DISCHARGE (OR APPROVED EQUAL).  
CAPACITY: TO 78 GPM  
HEAD: TO 19.5 FT

CONSULTANT:

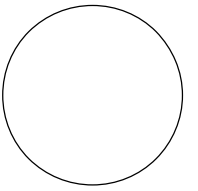

IOWA DEPARTMENT OF NATURAL RESOURCES

ENGINEERING SERVICES - WALLACE BUILDING  
502 E. 9TH ST., DES MOINES, IA 50319-0034



TREATMENT BUILDING PUMP

WATER TREATMENT SYSTEM REPLACEMENT  
LEWIS & CLARK STATE PARK

MONONA COUNTY, IOWA









NO.	BY DATE	REVISION

DRAWN BY: PROJECT NUMBER:  
M.H. 13-01-67-01

CHK'D BY: DATE:  
7/9/2015


SHEET No:

B.04

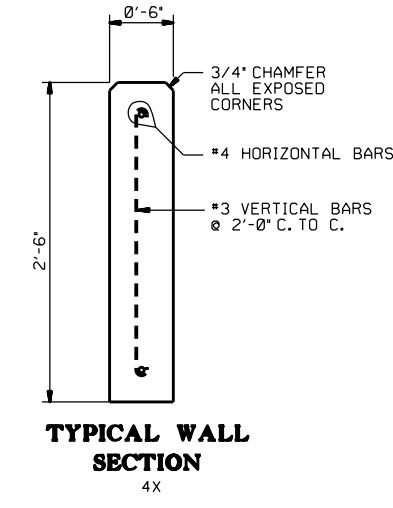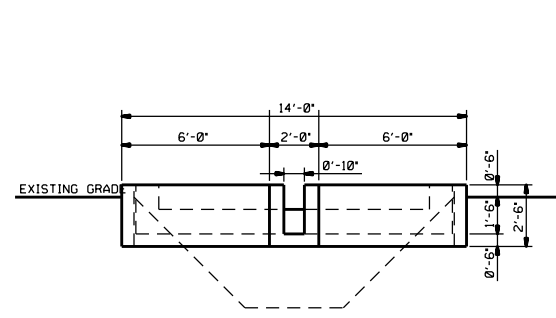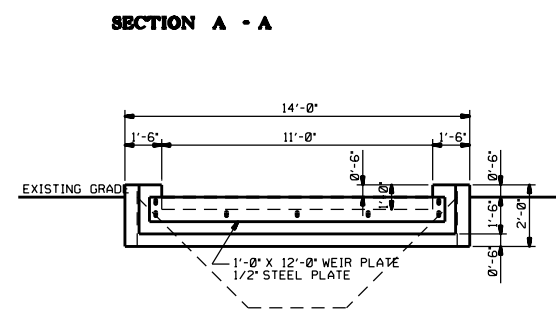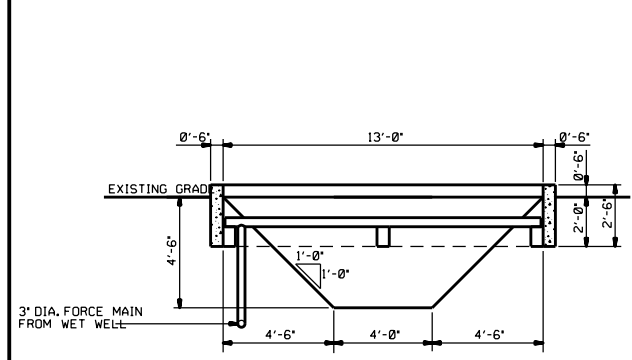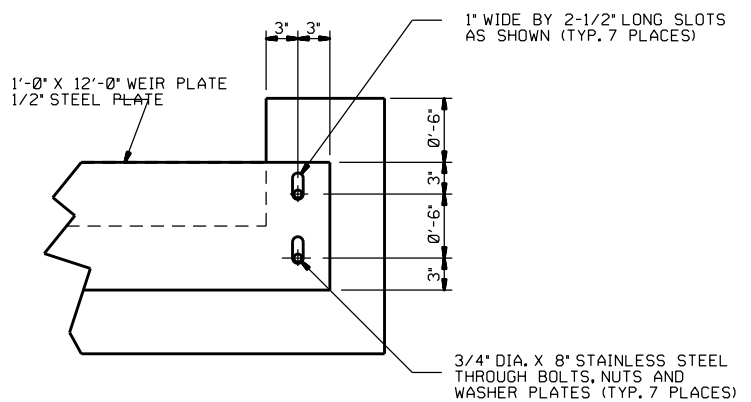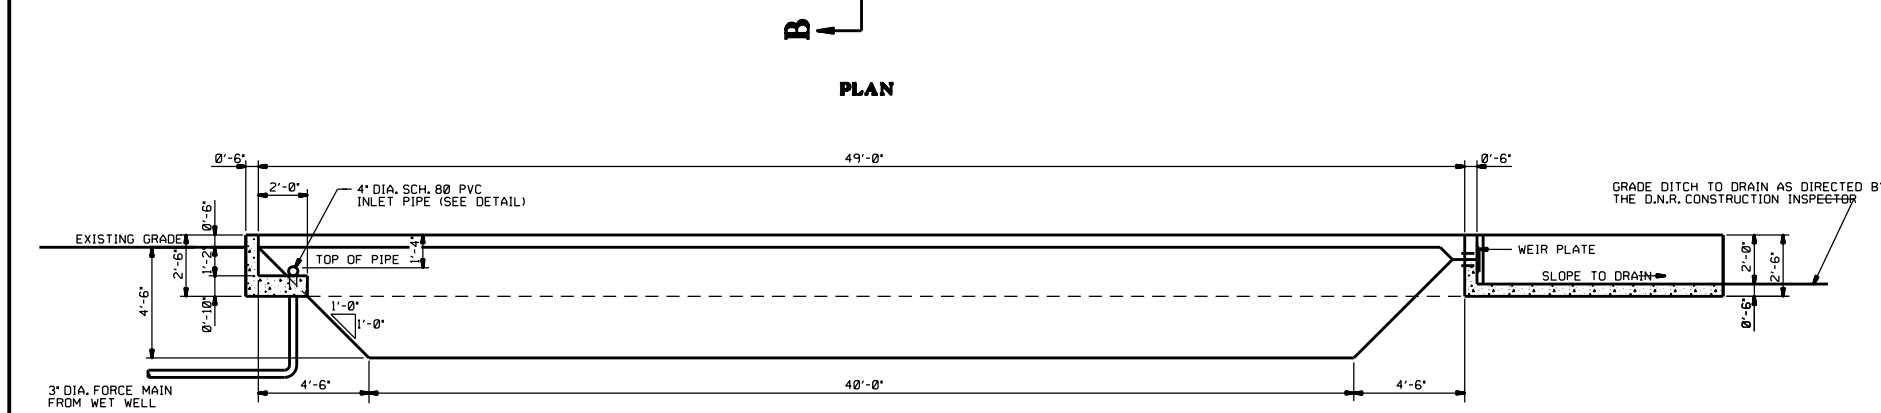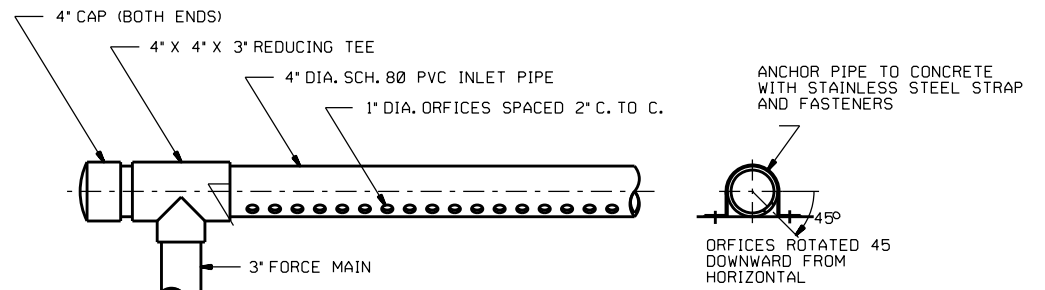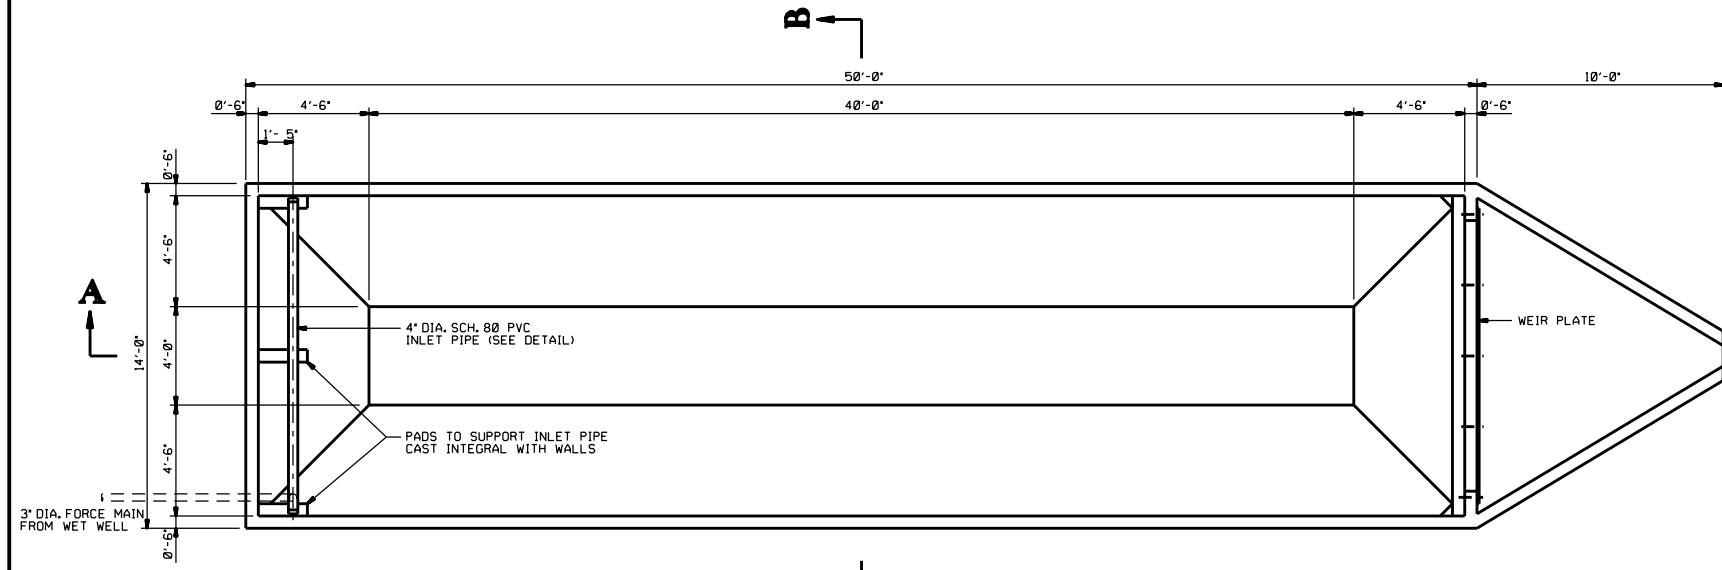

NOTE:  
ALL CONCRETE SHALL BE 4000 LB. MIX

CONSULTANT:

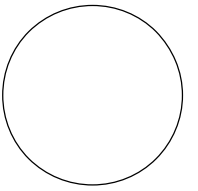

**IOWA DEPARTMENT OF NATURAL RESOURCES**

ENGINEERING SERVICES - WALLACE BUILDING  
502 E. 9TH ST., DES MOINES, IA 50319-0034



SETTLING BASIN


WATER TREATMENT SYSTEM REPLACEMENT  
**LEWIS & CLARK STATE PARK**

MONONA COUNTY, IOWA

NO.	BY	REVISION


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M.H. 13-01-67-02  
CHK'D BY: DATE:  
M.H. 7/9/2015

SHEET No: **B.05**

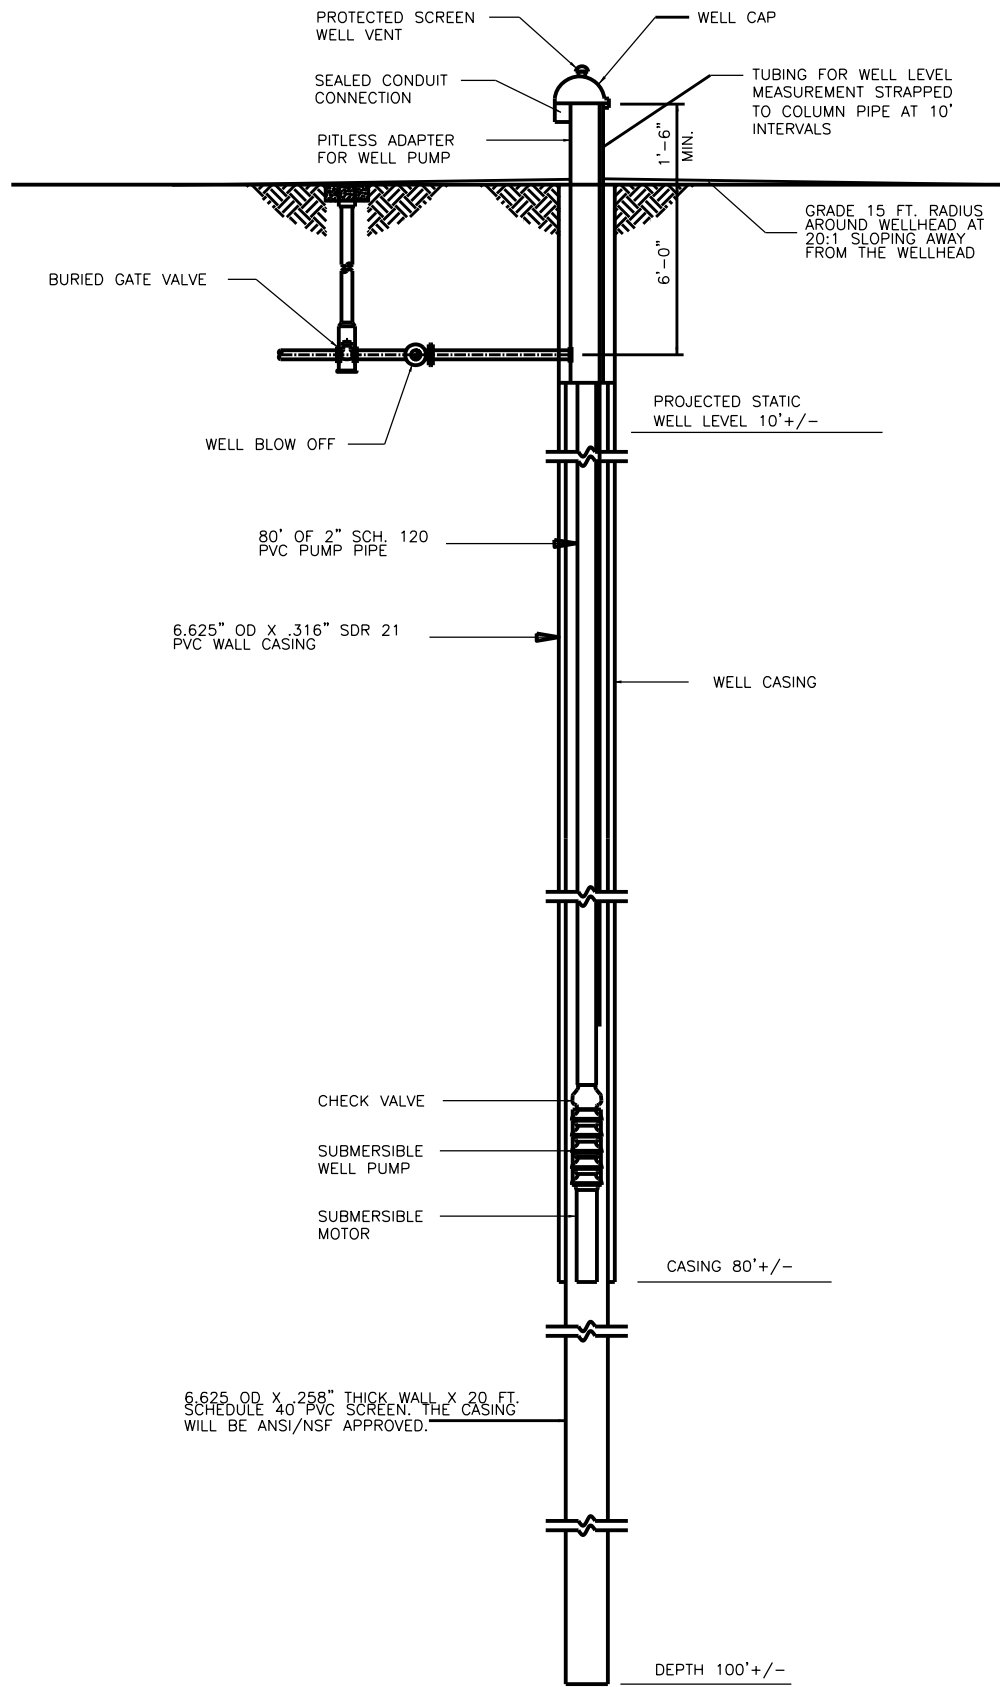


**WELL DETAIL**

NOT TO SCALE

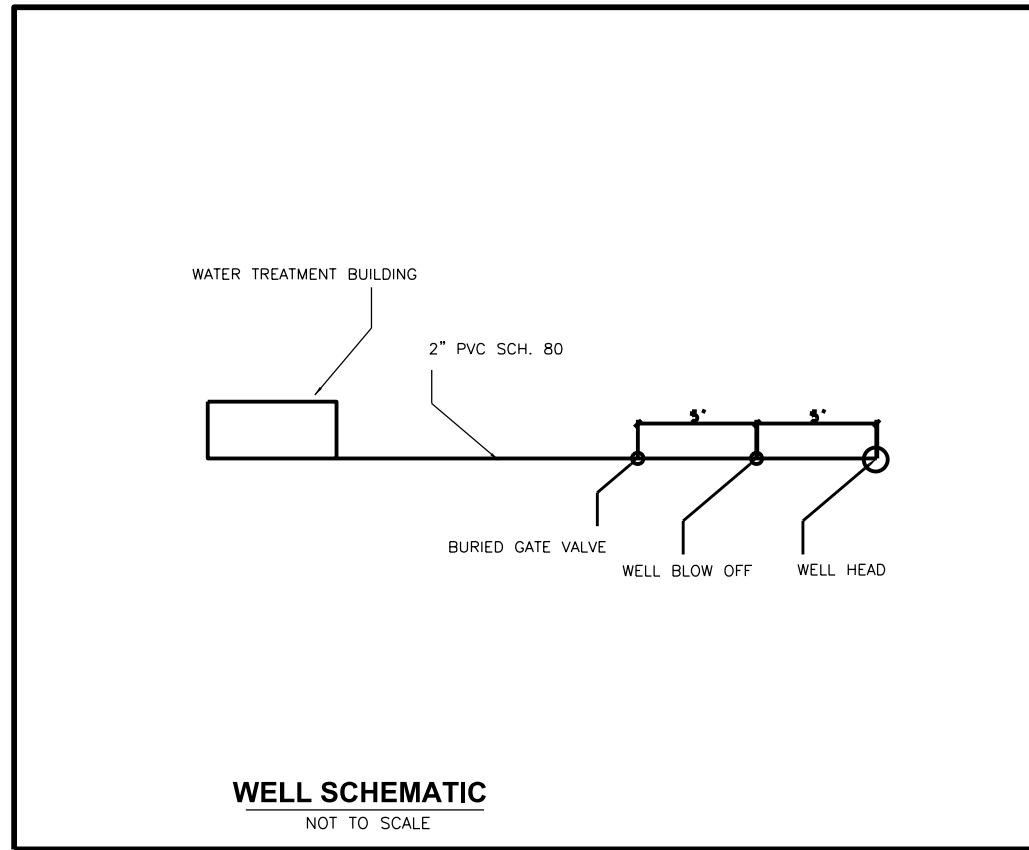

**WELL SCHEMATIC**

NOT TO SCALE

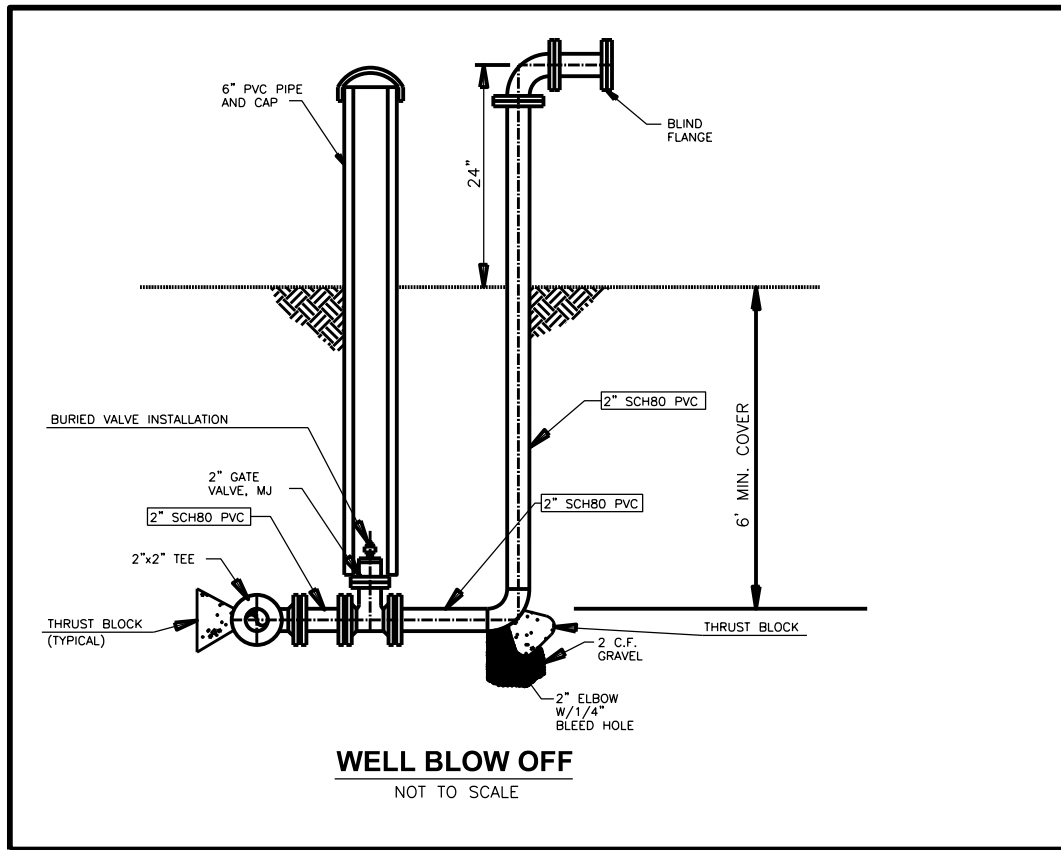


**WELL BLOW OFF**

NOT TO SCALE

1. ALL WORK WILL BE PERFORMED BY A CERTIFIED WELL DRILLER.
2. DNR WILL ONLY OBTAIN WELL CONSTRUCTION PERMIT. ALL OTHER NEEDED PERMITS WILL BE OBTAINED BY THE CONTRACTOR.

CONSULTANT:

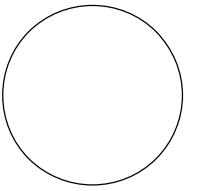

**IOWA DEPARTMENT OF NATURAL RESOURCES**

ENGINEERING SERVICES - WALLACE BUILDING  
502 E. 9TH ST., DES MOINES, IA 50319-0034



**WELL DETAILS**


WATER TREATMENT SYSTEM REPLACEMENT  
**LEWIS & CLARK STATE PARK**

MONONA COUNTY, IOWA


NO.	BY DATE	REVISION

DRAWN BY: PROJECT NUMBER:  
M.H. 13-01-67-02  
CHK'D BY: DATE:  
M.H. 7/9/2015  
SHEET No: B.06




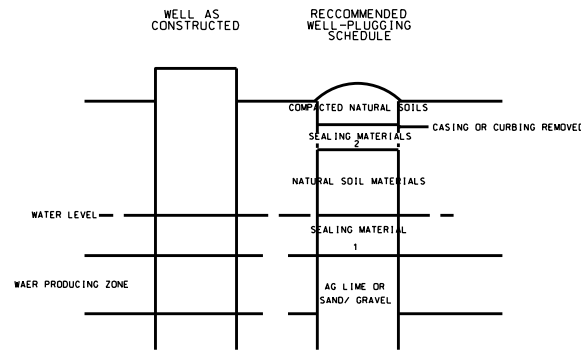


**LARGE DIAMETER DUG OR BORED WELLS**  
 1. GRADED BENTONITE, BENTONITE PELLETS, NEAT CEMENT  
 2. GRADED BENTONITE, BENTONITE PELLETS, NEAT CEMENT, SAND/CEMENT GROUT CONCRETE

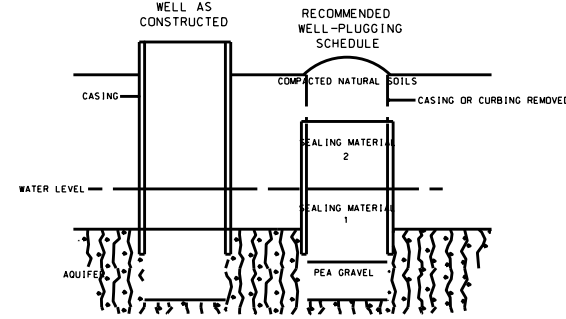


**BEDROCK WELL IN CONFINED AQUIFER**  
 1. BENTONITE PRODUCTS, NEAT CEMENT  
 2. BENTONITE PRODUCTS, NEAT CEMENT, SAND/GRAVEL GROUT, CONCRETE

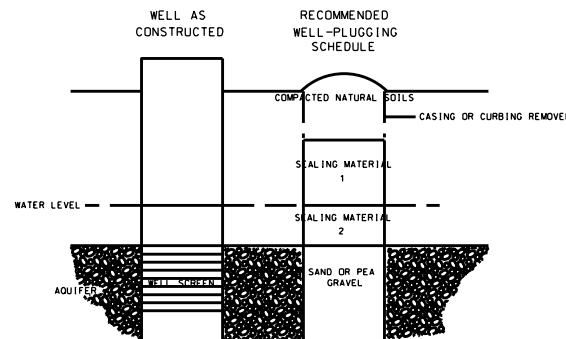

**ALLUVIAL AND GLACIAL-DRIFT WELLS**  
 1. BENTONITE PRODUCTS, NEAT CEMENT  
 2. BENTONITE PRODUCTS, NEAT CEMENT, SAND/CEMENT GROUT, CONCRETE

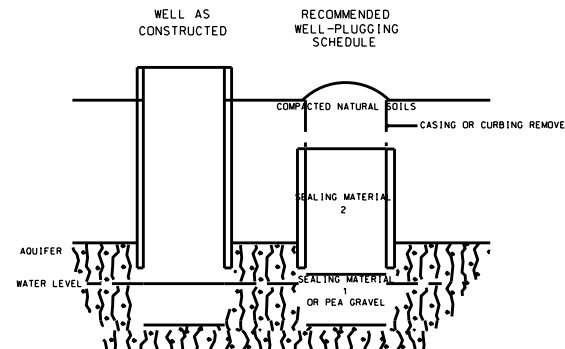

**BEDROCK WELL IN UNCONFINED AQUIFER**  
 1. BENTONITE PRODUCTS, NEAT CEMENT  
 2. BENTONITE PRODUCTS, NEAT CEMENT SAND/CEMENT GROUT, CONCRETE

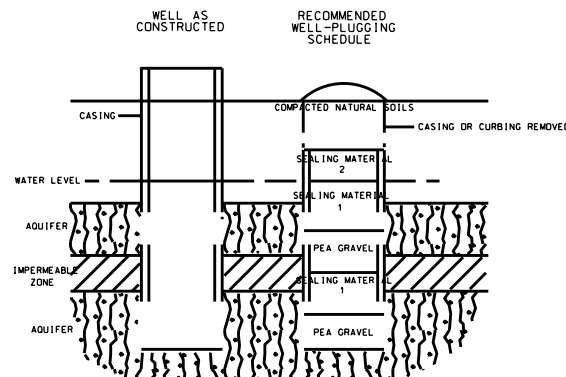


**LARGE DIAMETER DUG OR BORED WELLS**  
 1. GRADED BENTONITE, BENTONITE PELLETS, NEAT CEMENT  
 2. GRADED BENTONITE, BENTONITE PELLETS, NEAT CEMENT, SAND/CEMENT GROUT CONCRETE

NOMINAL (INCHES)	SCHEDULE OR STRENGTH	O.D. INCHES	I.D. INCHES	SECTION (FT <sup>2</sup> )	GALLONS/ LINEAL FT.	SACKS/ FT.	LINEAL FT./ SACK
2	40	2.375	2.07	.023	.17	.021	47.83
	80	4.500	1.94	.021	.15	.019	52.38
4	40	4.500	4.02	.088	.66	.080	12.50
	80		3.82	.080	.60	.073	13.75
5	40	5.563	5.04	.139	1.04	.126	7.91
	80		4.81	.126	.95	.115	8.73
6	40	6.625	6.06	.201	1.50	.182	5.47
	80		5.76	.181	1.35	.165	6.08
8	30	8.625	8.07	.355	2.66	.323	3.10
	40		7.98	.347	2.60	.316	3.17
	80		7.62	.317	2.37	.288	3.47
10	30	10.75	10.13	.560	4.19	.510	1.96
	40		10.02	.548	4.10	.498	2.01
	XS		9.75	.519	3.88	.471	2.12
12	30	12.75	12.09	.797	5.96	.725	1.38
	STD		12.00	.785	5.88	.714	1.40
	40		11.93	.777	5.81	.707	1.42
14	STD	14.00	13.25	.957	7.16	.871	1.15
	XS		13.00	.922	6.90	.838	1.19
16	STD	16.00	15.24	1.268	9.49	1.153	.87
	XS		15.00	1.227	9.18	1.116	.90
18	STD	18.00	17.25	1.623	12.14	1.476	.68
20	STD	20.00	19.25	2.021	15.12	1.837	.54
24	STD	24.00	23.25	2.948	22.06	2.680	.37
30	STD	30.00	29.25	4.666	34.91	4.242	.24

REFERENCE: SEE IOWA DNR PUBLICATION SERIES NO. 15 FOR FURTHER DETAILS

CONSULTANT:

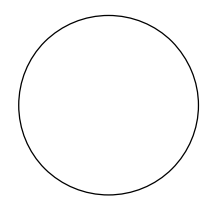

**IOWA DEPARTMENT OF NATURAL RESOURCES**

ENGINEERING SERVICES - WALLACE BUILDING  
 502 E. 9TH ST., DES MOINES, IA 50319-0034



WELL CAPPING DETAILS

WATER TREATMENT SYSTEM REPLACEMENT  
 LEWIS & CLARK STATE PARK


MONONA COUNTY, IOWA

NO.	BY DATE	REVISION


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 CHK'D BY: DATE:  
 7/9/2015

SHEET No: **B.07**




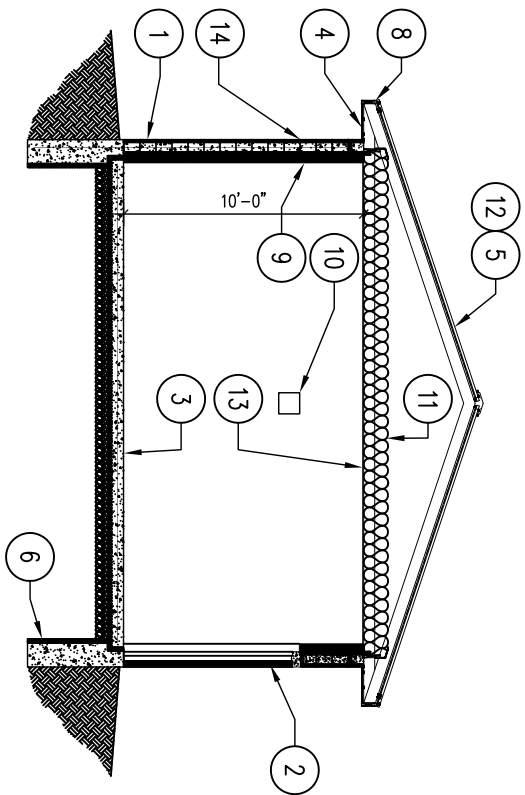


05 BUILDING ELEVATION  
SCALE: 1/8" = 1'-0"

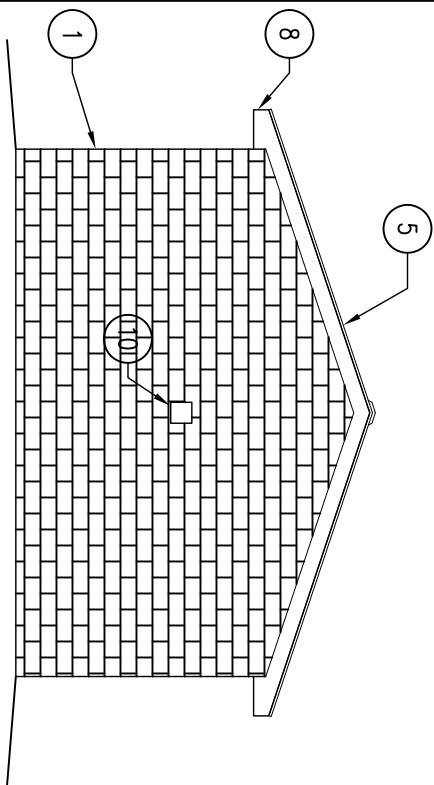


04 BUILDING ELEVATION  
SCALE: 1/8" = 1'-0"

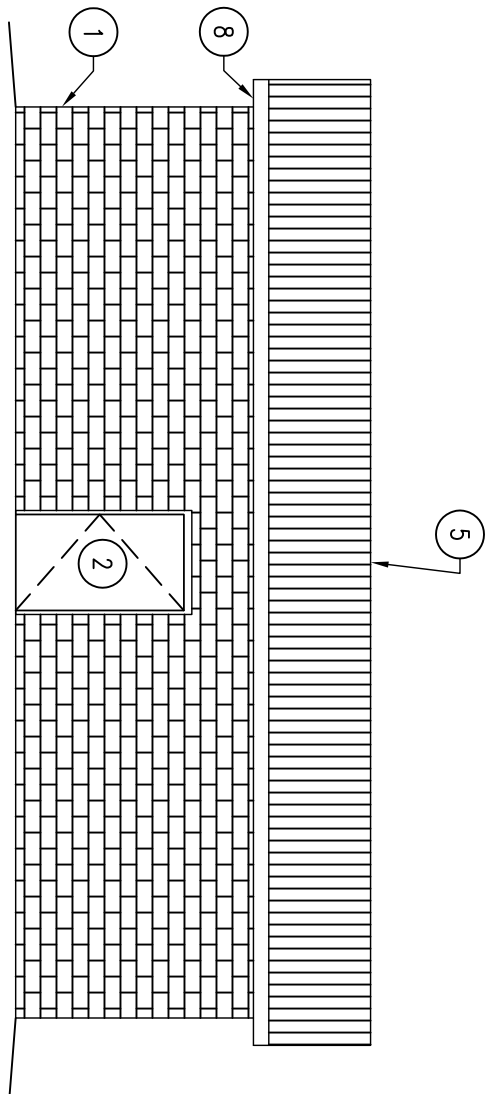

03 BUILDING ELEVATION  
SCALE: 1/8" = 1'-0"

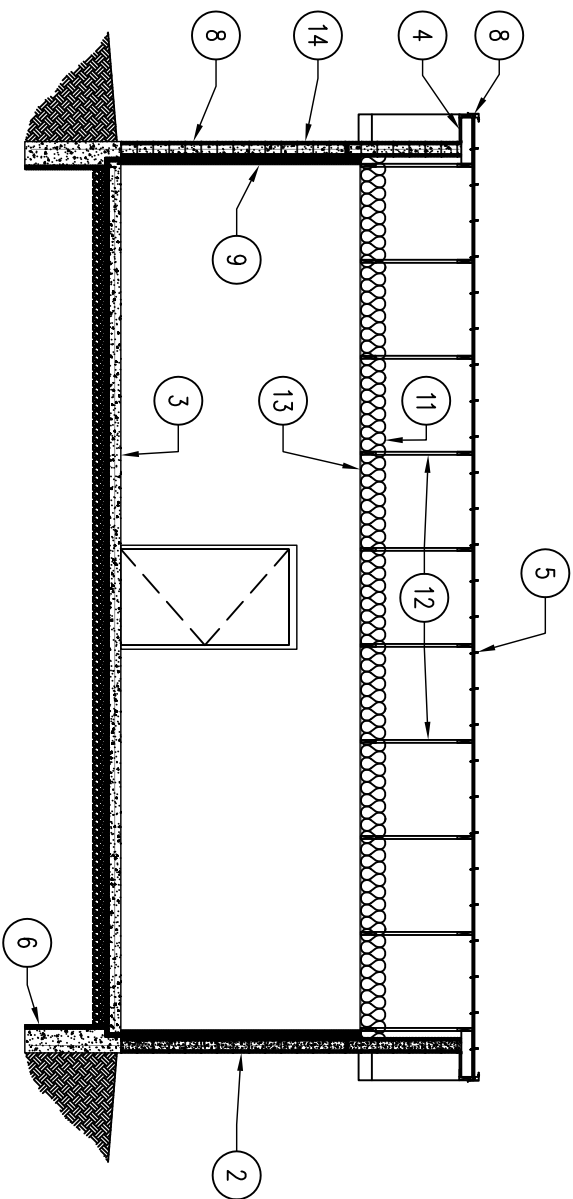

02 BUILDING SECTION  
SCALE: 1/8" = 1'-0"

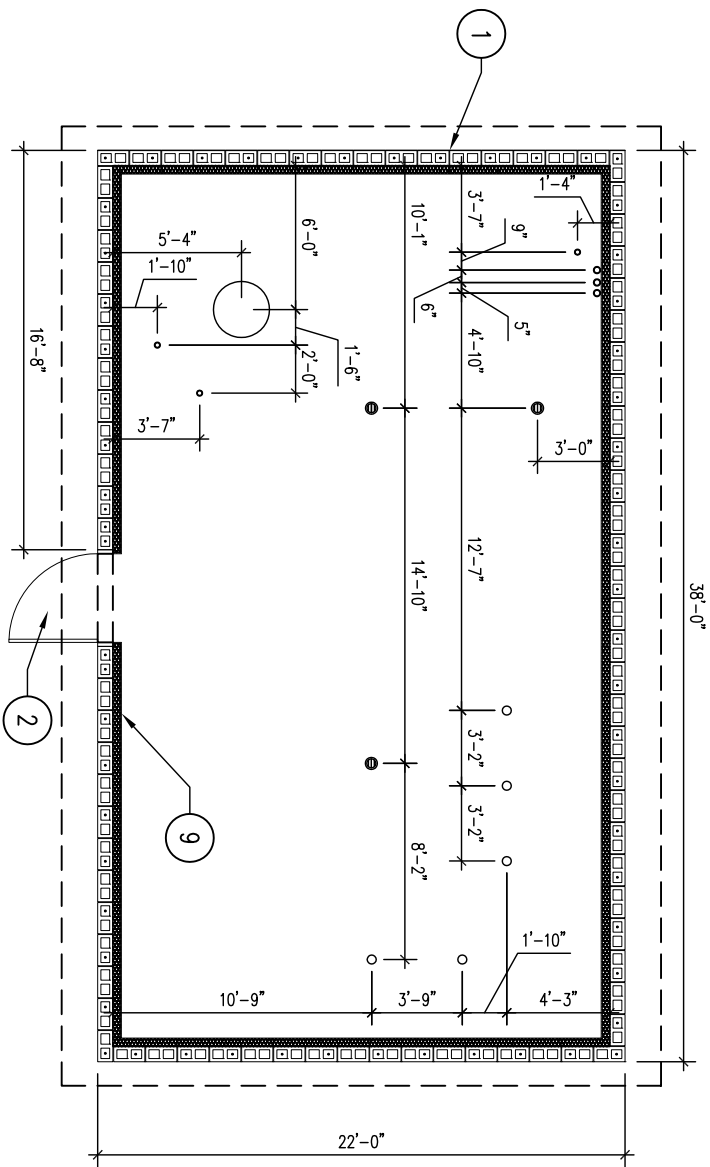

01 REFERENCE FLOOR PLAN  
SCALE: 1/8" = 1'-0"

KEYNOTES

1. 8X8X16 CMU SPLIT-FACE BLOCK WALL, WITH #4 REBAR EVERY THIRD FULLY-GROUT ALL CELLS.
2. 16 GAUGE 48X96 STEELCRAFT #1 SERIES FLUSH DOOR WITH POLYURETHANE INSULATION AND STEEL FRAME, BUTT IN JAMBS.
3. 6" CONCRETE SLAB WITH #4 REBAR EVERY 32" O.C. BOTH DIRECTIONS. SLAB TO RECEIVE 2" RIGID SUB-SLAB INSULATION UNDER ENTIRE SLAB, TAPED AND SEALED, AS SHOWN, WITH 6" SUBBASE ROCK.
4. STEEL VENTED FLUSH SOFFIT PANELS, TO MATCH ROOF COLOR.
5. 2x GA. PAC-CLAD STEEL SNAP-CLAD ROOF WITH DARK BRONZE COLOR AND VENTED ROOF.
6. 42" MINIMUM DEPTH TRENCH FOOTING 12" WIDE #4 REBAR 12" O.C. BOTH DIRECTIONS.
7. METAL DRIP EDGE, MATCH ROOF COLOR.
8. W/48 P/ASDA WITH COIL METAL, MATCH ROOF COLOR.
9. 3 3/8" 26 GA. GALVANIZED STEEL STUDS, 24" O.C. WITH CLOSED CELL SPRAY FOAM ENTIRE CAVITY. SHEATH WALL AND CEILING WITH 1/2" REWALL NAKED BOARD.

GENERAL NOTES

10. CUT A TO 1/2" X 10 1/2" HOLE IN MASONRY FOR FAN INSTALLATION, REFER TO CIVIL PLANS FOR MORE INFORMATION.
  11. R-42 BATT INSULATION OVER 10MIL VAPOR BARRIER.
  12. TRUSS AND TRUSS DESIGN BY CONTRACTOR.
  13. 1/2" REWALL NAKED BOARD.
  14. CMU SPLIT-FACE BOND BEAM AROUND ENTIRE PERIMETER OF BUILDING, MATCH BUILDING CMU.
  15. 2X6 OUTRIGGER FOR GABLED END OF ROOF.
- A. CONTRACTOR TO VERIFY ALL DIMENSIONS PRIOR TO CONSTRUCTION.
  - B. CONTRACTOR TO SUBMIT SAMPLES OF SPLIT-FACE BLOCK FOR APPROVAL PRIOR TO CONSTRUCTION FOR COLOR SELECTION.
  - C. CONTRACTOR TO VERIFY ALL PLUMBING REQUIREMENTS AND PENETRATIONS IN BUILDING SLAB. REFER TO MECHANICAL LAYOUT DRAWINGS FOR EXACT DIMENSIONS AND PLACEMENT OF DRAIN HOLE AND SLAB PENETRATIONS.


WATER TREATMENT BUILDING FOR:  
**LEWIS & CLARK STATE PARK**

21914 PARK LOOP, ONAWA MONONA COUNTY, IA



IOWA DEPARTMENT OF  
NATURAL RESOURCES

ENGINEERING SERVICES - WALLACE BUILDING  
502 E. 9TH ST., DES MOINES, IA 50319-0034  
P: 515.725.8200  
F: 515.725.8202

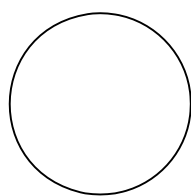


SEAL


SHEET NO.  
**D.01**

DATE  
11.18.2015


PROJECT NUMBER  
13-01-67-02

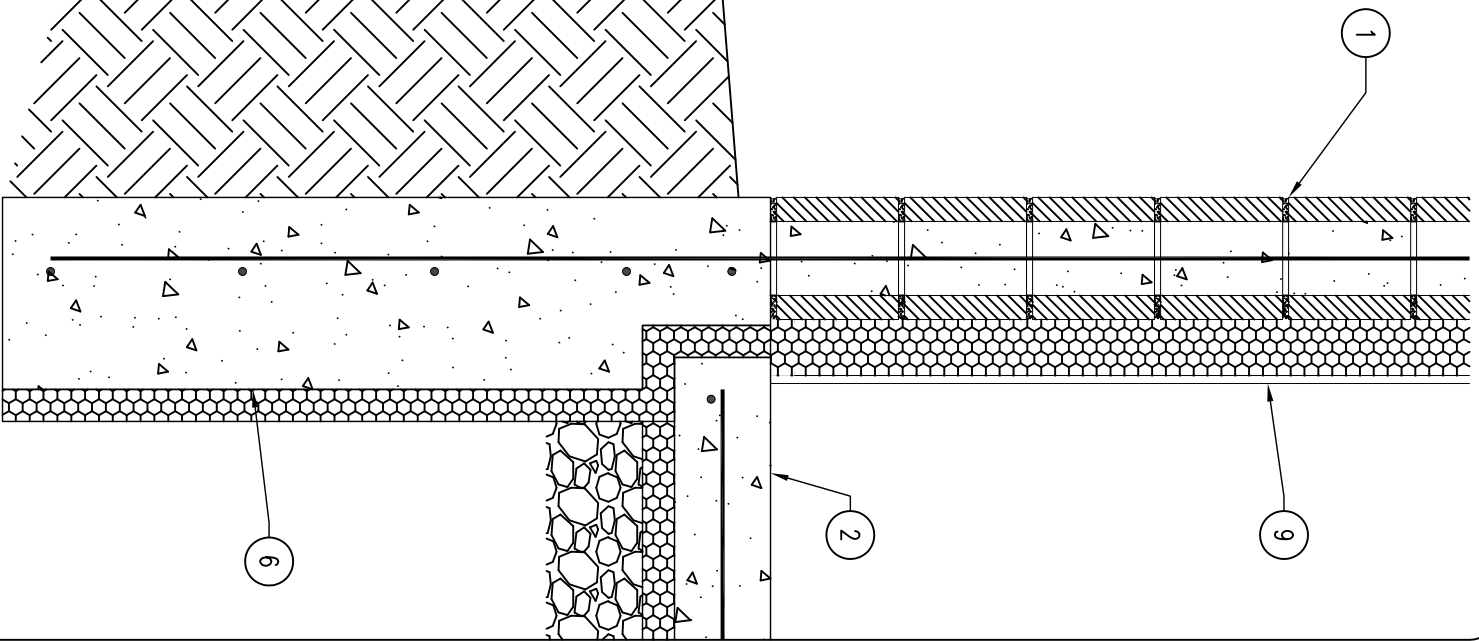

**03** DETAIL – TRENCH FOOTING  
SCALE: 1" = 1'-0"

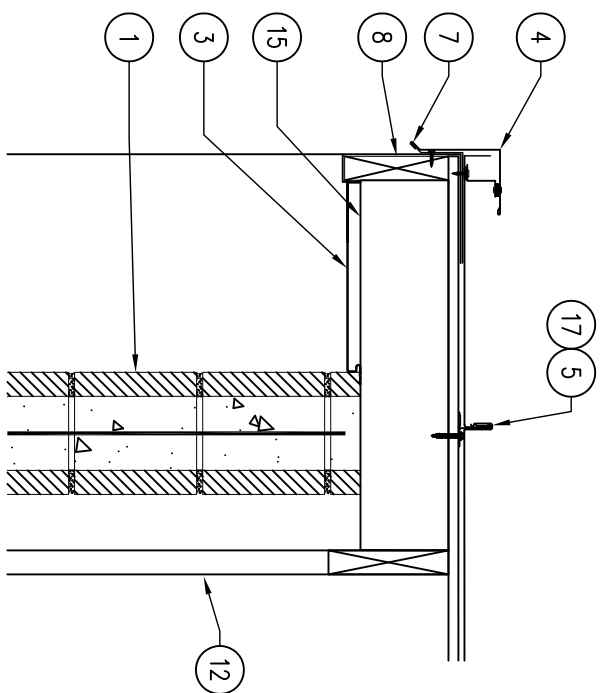

**02** DETAIL – ROOF GABLE  
SCALE: 1" = 1'-0"

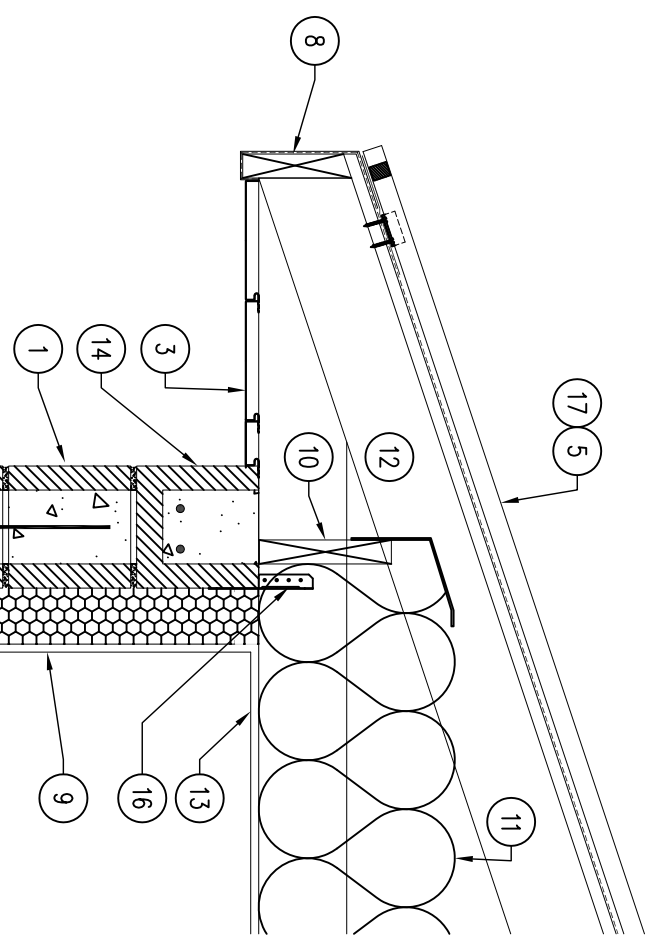

**01** DETAIL – ROOF EAVE  
SCALE: 1" = 1'-0"

**05** NOT USED  
SCALE: 1/8" = 1'-0"


**04** NOT USED  
SCALE: 1/8" = 1'-0"

KEYNOTES

1. 8X8X16 CMU SPLIT-FACE BLOCK WALL, WITH #4 REBAR EVERY THIRD CELL AND HORIZONTAL BED JOINT REINFORCEMENT EVERY 32" VERTICALLY, FULLY-GROUT ALL CELLS.
2. 6" CONCRETE SLAB WITH #4 REBAR EVERY 32" O.C. BOTH DIRECTIONS, SLAB TO RECEIVE 2" RIGID SUB-SLAB INSULATION UNDER ENTIRE SLAB, TAPED AND SEALED, AS SHOWN, WITH 6" SUBBASE ROCK.
3. STEEL VENTED FLUSH SOFFIT PANELS, TO MATCH ROOF COLOR.
4. ROOF GABLE RAKE BY ROOFING MANUFACTURER.
5. 24 GA. P/B-C/LAD STEEL SNAP-C/LAD ROOF WITH DARK BRONZE COLOR AND VENTED RIDGE WITH WATER & ICE SHIELD OVER ENTIRE ROOF.
6. 42" MINIMUM DEPTH TRENCH FOOTING 12" WIDE, #4 REBAR 12" O.C. BOTH DIRECTIONS.
7. METAL DRIP EDGE, MATCH ROOF COLOR.
8. 2X FASCIA, WRAP FASCIA WITH COIL METAL, MATCH ROOF COLOR.
9. 3 3/8" 26 GA. GALVANIZED STEEL STUDS, 24" O.C. WITH CLOSED CELL SPRAY FOAM ENTIRE CAVITY. SHEATH WALL AND CEILING WITH 1/2" REWALL, NAKED BOARD.
10. INSULATION BATTLE.
11. R-42 BATT INSULATION OVER 10ML VAPOR BARRIER.
12. TRUSS AND TRUSS DESIGN BY CONTRACTOR.

GENERAL NOTES

13. 1/2" REWALL NAKED BOARD.
  14. CMU SPLIT-FACE BOND BEAM AROUND ENTIRE PERIMETER OF BUILDING, MATCH BUILDING CMU.
  15. 2X6 OUTRIGGER FOR GABLED END OF ROOF.
  16. SIMPSON TRUSS CLIP, AS REQUIRED BY CODE.
  17. 1/2" PLYWOOD ROOF SHEATHING OVER ENTIRE ROOF.
- A. CONTRACTOR TO VERIFY ALL DIMENSIONS PRIOR TO CONSTRUCTION.  
 B. CONTRACTOR TO SUBMIT SAMPLES OF SPLIT-FACE BLOCK FOR APPROVAL PRIOR TO CONSTRUCTION FOR COLOR SELECTION.  
 C. CONTRACTOR TO VERIFY ALL PLUMBING REQUIREMENTS AND PENETRATIONS IN BUILDING SLAB.

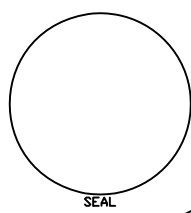

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**WATER TREATMENT BUILDING FOR:  
LEWIS & CLARK STATE PARK**  
 21914 PARK LOOP, ONAWA MONONA COUNTY, IA

SHEET NO. **D.02**  
 DRAWN BY: **13-01-67-02**  
 DATE: **11.18.2015**



Demolish, haul & dispose existing 28'X28' water treatment building including pressure tanks, mixing tanks and other accessories. All water mains to be disconnected and plugged. Site will be graded and seeded. Demolition permit is responsibility of the contractor. Please also see the attached asbestos inspection report in specs. Contractor is responsible for all clearing & grubbing. DNR will remove any material that would impede construction.

Demolish and remove a 28'X24'X6' deep, in ground water storage tank and plug water mains. Fill hole with soil and seed.

New water main to existing distribution line. Connect new line and disconnect & plug existing old line.

New well. Sheet B.06

Approx. location of Transformer


New 36'X20' water treatment building. Sheet B.01 - B.04 ALSO D.01 & D.02.

Remove & reinstall fencing as necessary for construction


Plug existing well. Sheet B.07

40'X14' Settling Basin. Sheet B.05

The locations of Treatment building, Settling Basin and New Well will be marked by DNR inspector.

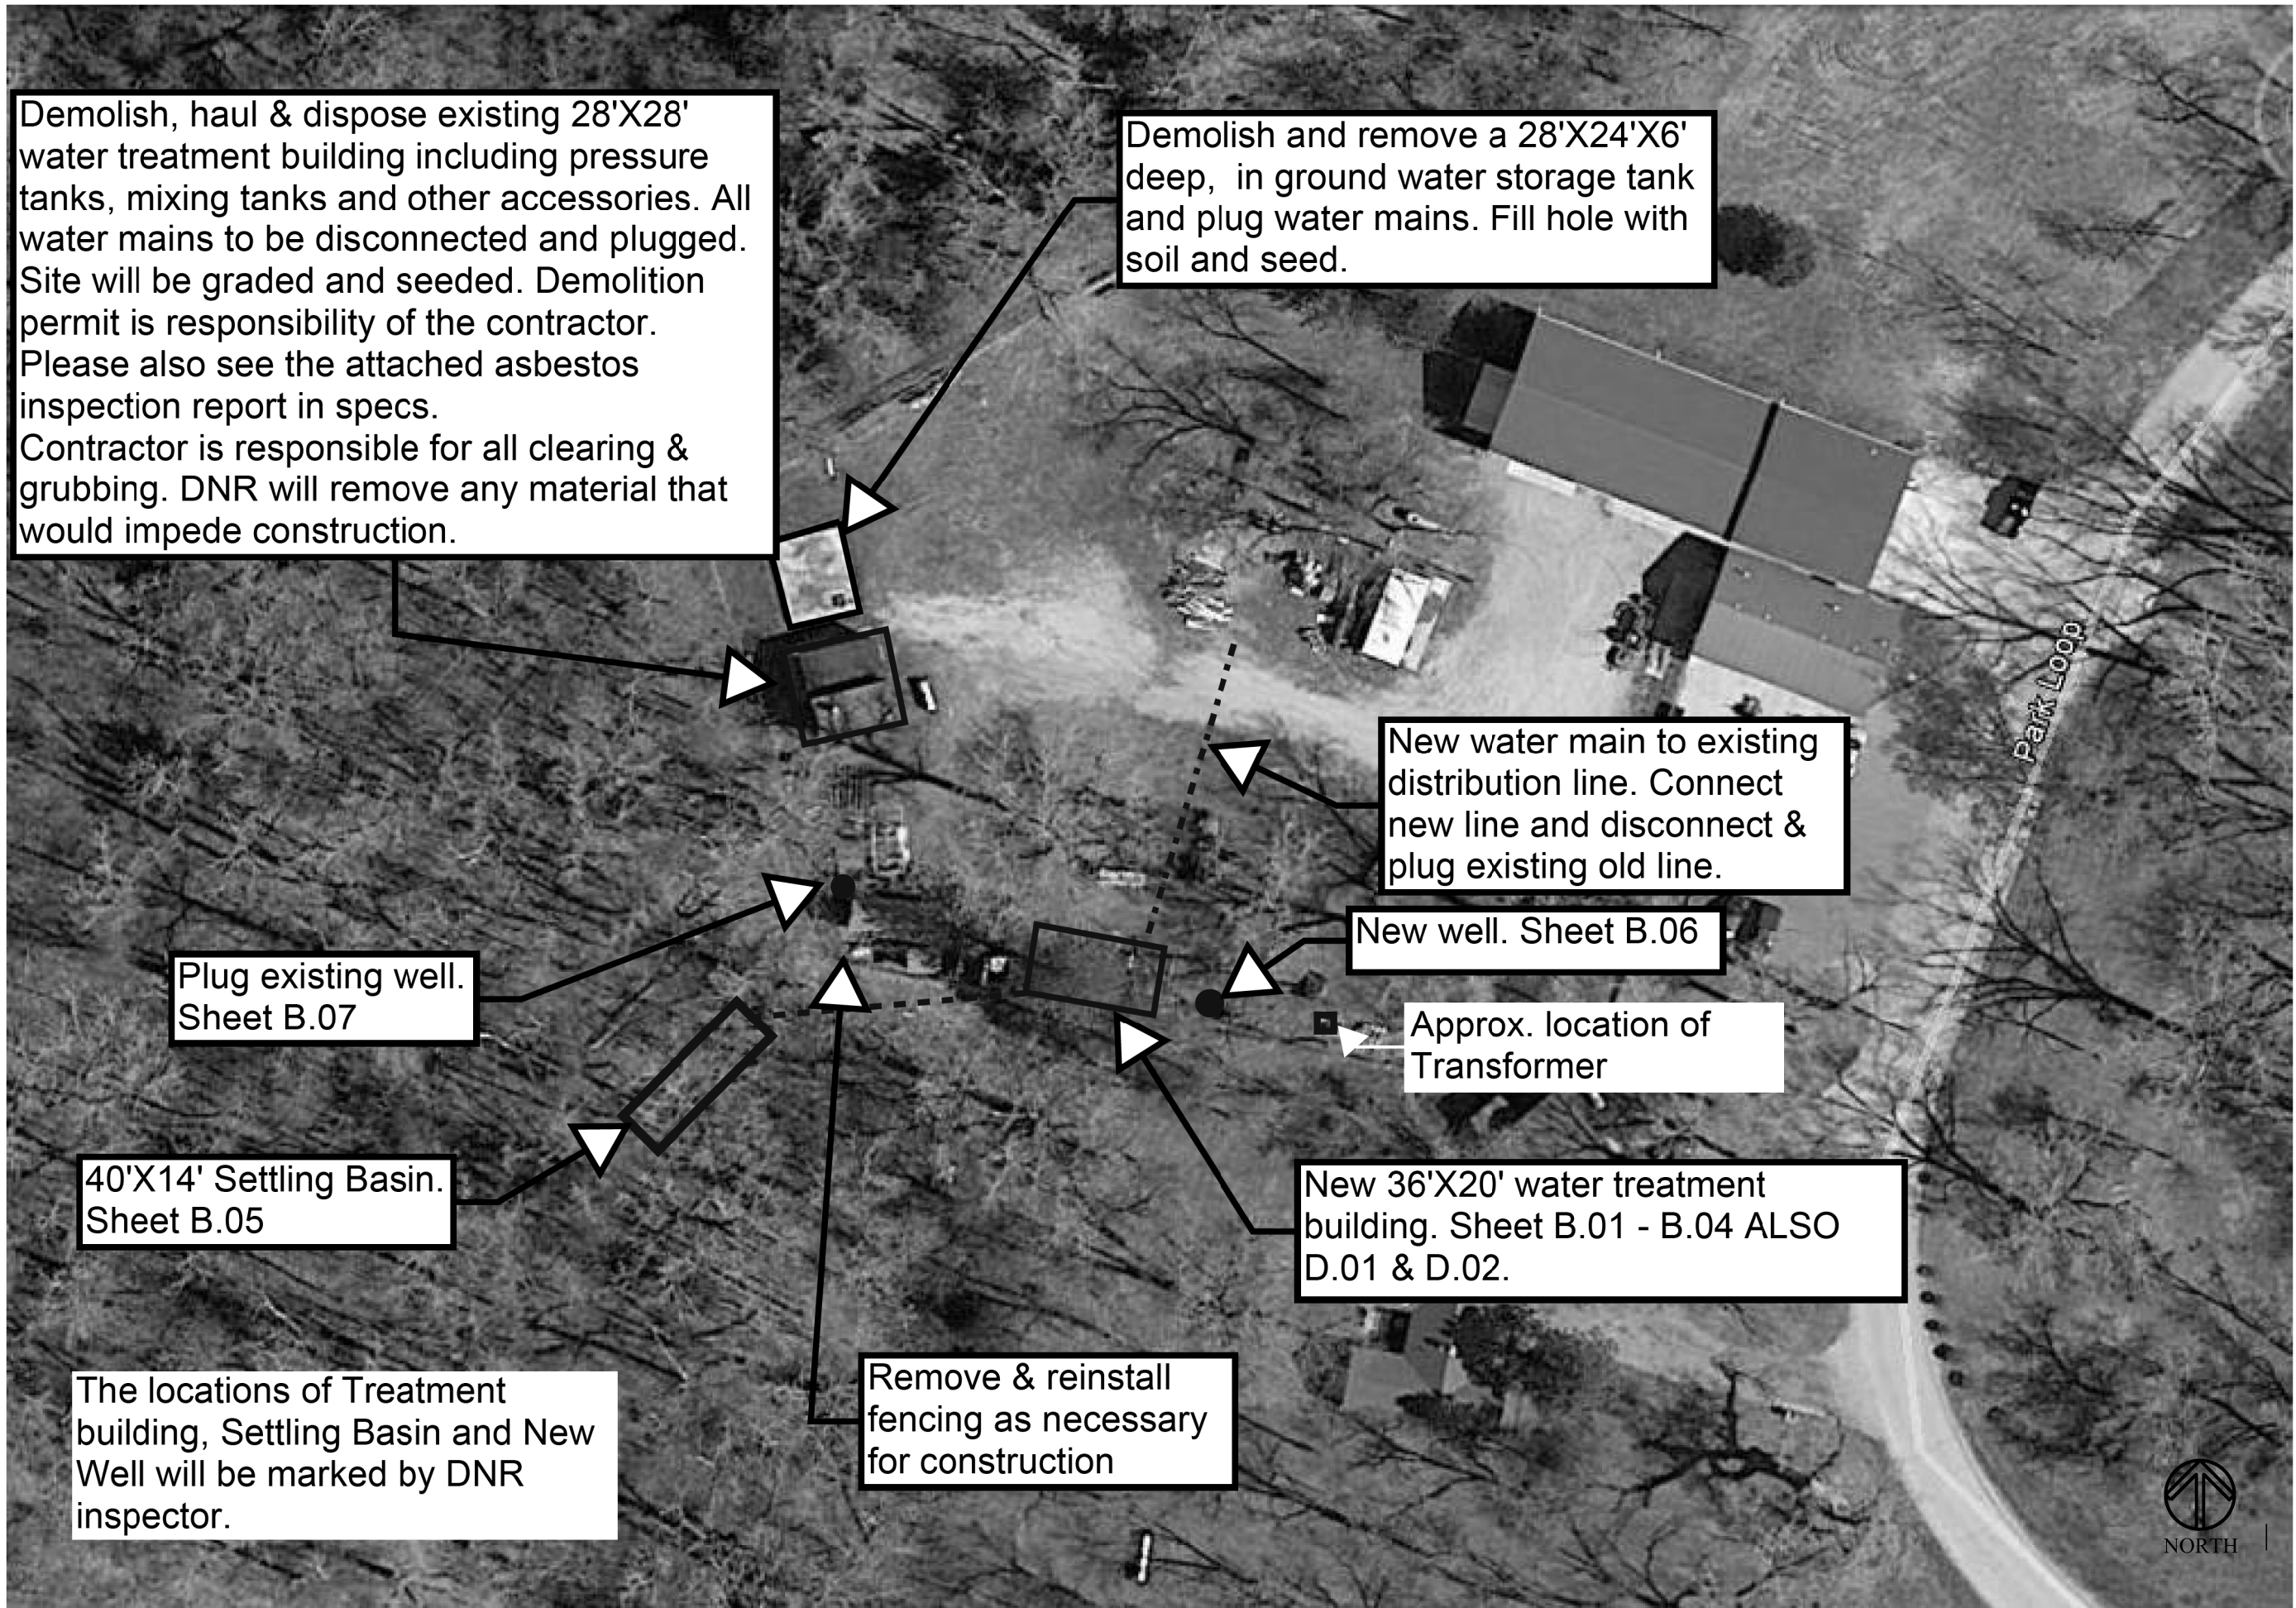

CONSULTANT:

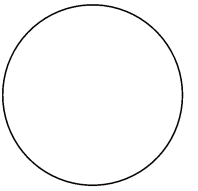

**IOWA DEPARTMENT OF NATURAL RESOURCES**  
 ENGINEERING SERVICES - WALLACE BUILDING  
 502 E. 9TH ST., DES MOINES, IA 50319-0034



SITE PLAN

WATER TREATMENT SYSTEM REPLACEMENT  
 LEWIS & CLARK STATE PARK

MONONA COUNTY, IOWA

NO.	BY	REVISION

DRAWN BY: PROJECT NUMBER:  
 M.H. 13-01-67-02  
 CHK'D BY: DATE:  
 7/9/2015

SHEET No: D.03